

SITE PLAN APPROVAL & NOTICE OF INTENT

WINTER VALLEY RESIDENCES

BUILDING 6 AT 600 CANTON AVENUE


MILTON, MASSACHUSETTS

November 4, 2022

LIST OF DRAWINGS

- SP-1 EXISTING CONDITIONS PLAN
- SP-1 SITE PREPARATION PLAN
- C-1 LAYOUT AND MATERIALS PLAN
- C-2 GRADING AND UTILITY PLAN
- C-3 PLANTING PLAN
- C-4 SITE DETAILS
- C-5 SITE DETAILS

ZONING TABLE		
ZONE: RESIDENCE D-1 USE: SENIOR HOUSING	REQUIRED	PROVIDED
MIN. LOT AREA	20 ACRES	24.5+/- ACRES
MIN. LOT FRONTAGE	150 FT	152 +/- FT
MIN. SIDE YARD	40 FT	68 FT & 77 FT
MIN. REAR YARD	30 FT	679 FT
MIN. SETBACK FROM PUBLIC WAY	150 FT	1,479 FT
MAX. NUMBER OF UNITS	196	196 160(EX)+36(PR)=196
PARKING:	1 SPACE /2 UNITS 36 UNITS REQUIRE 18 SPACES	29 TOTAL SPACES [8 REMOVED] [37 ADDED]

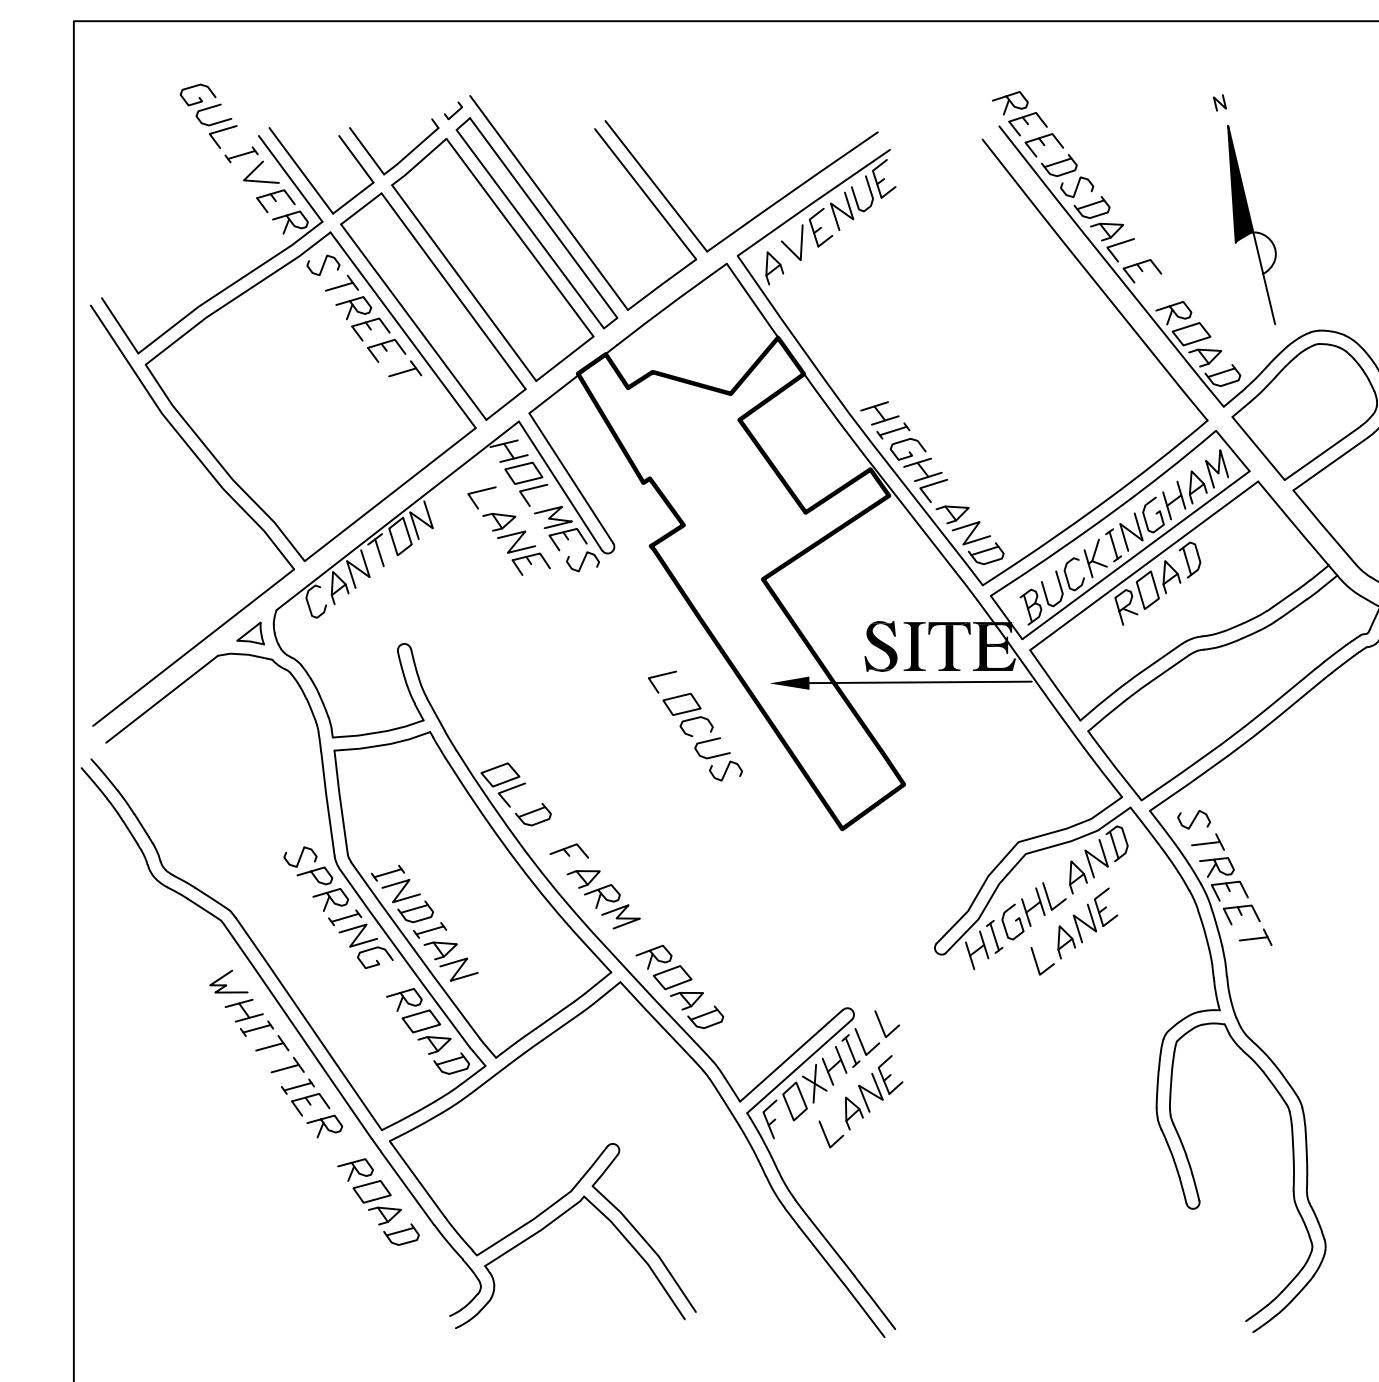

LOCUS MAP

NTS

CIVIL ENGINEER/ LANDSCAPE ARCHITECT

DeVellis Zrein Inc.
P.O. Box 307 Foxborough, MA 02035
508.473.4114 (jim@develliszrein.com)

ARCHITECT


John V. Downie Architect
285 Auburndale Avenue, Newton MA 02466


SURVEYOR

Precision Land Survey Inc.
32 Turnpike Rd Southborough, MA 01772

WETLAND SCIENTIST

Beals Associates Inc.
2 Park Plaza Suite 200 Boston, MA 02116

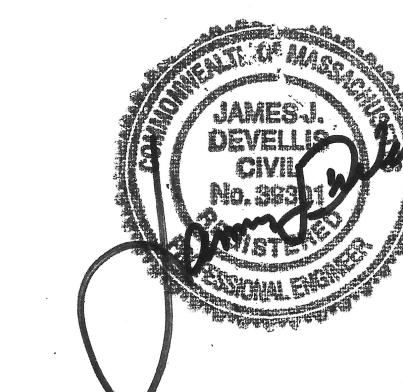

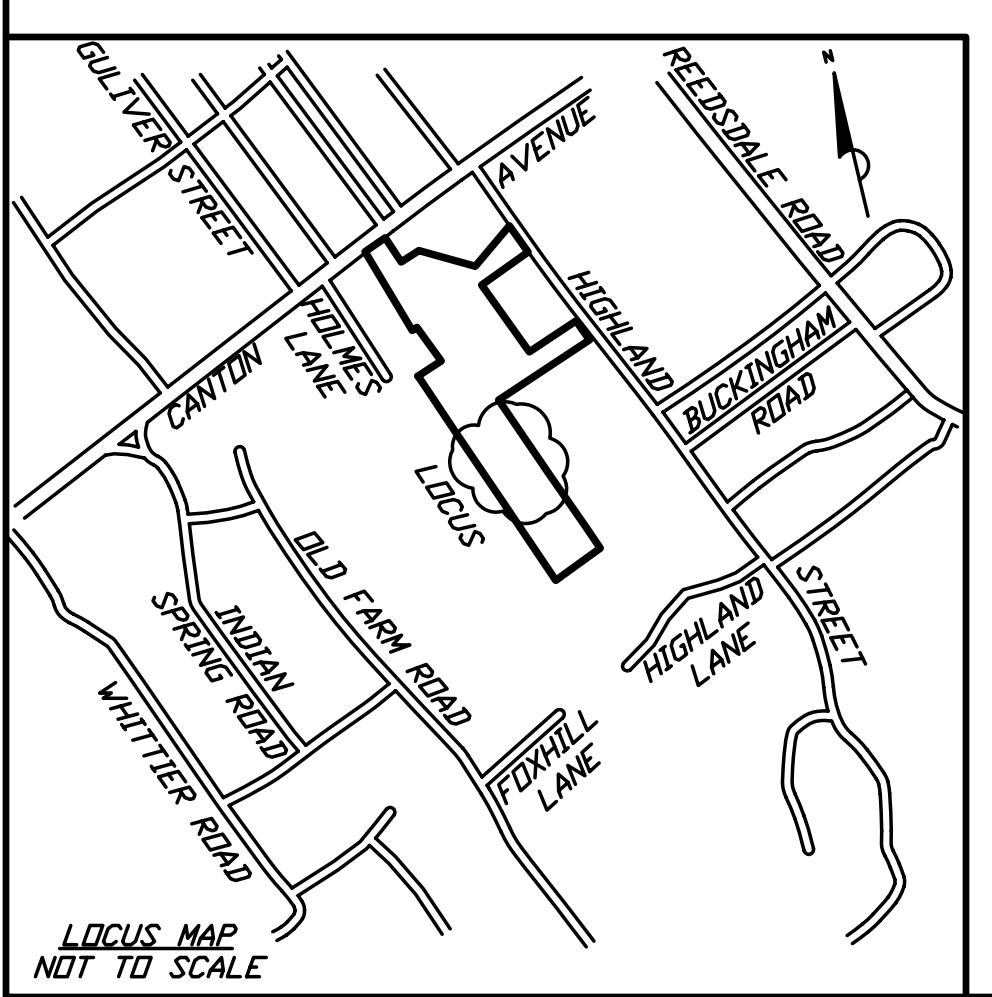

REFERENCES
NORFOLK COUNTY REGISTRY OF DEEDS
PLAN NO. 577 OF 1997 IN PLAN BOOK 450
• 587 • 1978 • 269
• 969 • 1977 • 264
• 579 • 1974 • 245
• 64 • 1973 • 229
• 651 • 1970 • 227
• 1345 • 1955 • 200
• 59 • 1946 • 138
• 1895 • 1905 • 40
• 764 • 1980 IN DEED BOOK 5785 PAGE 2
• 94 • 1958 • 3617 • 91
• 738 • 1954 • 3264 • 378
PLAN IN DEED BOOK 963 PAGE 509

UNDERGROUND UTILITIES WERE COMPILED FROM AVAILABLE RECORD PLANS OF UTILITY COMPANIES AND PUBLIC AGENCIES AND ARE APPROXIMATE ONLY. BEFORE DESIGN AND CONSTRUCTION CALL "DIG SAFE" 1-888-344-7233. SOME DATA IS CONFLICTING AND CAN ONLY BE VERIFIED BY EXCAVATION.

LEGEND
BERM
BFA
BH
BT CONC
CB
CB/EPLP
CC
CLF
CONC
CTV
DBB
DMH
DRA
GC
GEN
GG
HYD
LP
LST
MH
S
SB/DH
SMH
TRANS
UP
WF
WG
.....
BITUMINOUS CONCRETE BERM
BUILDING FOOTPRINT AREA
BUILDING HEIGHT
BITUMINOUS CONCRETE
CATCH BASIN
CONCRETE BOUND/PLUG
CONCRETE CURB
CHAIN LINK FENCE
CONCRETE
CABLE TELEVISION
DOUBLE DRAIN/BASIN
DRAIN MANHOLE
DRIVE MANHOLE
GRANITE CURB
GENERATOR
GAS GATE
HYDRANT
LIGHT POLE
LANDSCAPE TIMBER
MANHOLE
SIGN
STONE BOUND/DRILLHOLE
SEWER MANHOLE
SEWER TRANSFORMER
UTILITY POLE
WOOD FENCE
WATER GATE
TREE LINE
OVERHEAD WIRE

NOTES
1) ELEVATIONS SHOWN HEREON ARE BASED ON THE NORTH AMERICAN VERTICAL DATUM OF 1988 AS DETERMINED BY GPS OBSERVATIONS AND AN OPUS REDUCTION PERFORMED 2/26/2021.
2) SNOW ON GROUND AT TIME OF SURVEY.
3) ONLY SELECT UTILITY INFORMATION WAS AVAILABLE AND SOME LINES WERE NOT ABLE TO BE SHOWN.
4) THIS PLAN AND THE SURVEY ON WHICH IT IS BASED WERE PREPARED WITHOUT THE BENEFIT OF A CURRENT TITLE REPORT AND ARE SUBJECT TO THE FINDINGS SUCH A REPORT MAY DISCLOSE.
5) OWNER: WINTER VALLEY RESIDENCES, INC.
DEED BOOK 5522 PAGE 333
6) WETLAND FLAGS WERE HUNG BY OTHERS.

FLOOD NOTE
BY GRAPHIC PLOTTING ONLY THE PARCEL SHOWN HEREON IS LOCATED IN ZONE X AS SHOWN ON FLOOD INSURANCE RATE MAP Nos. 25021C0202E & 25021C0064F, EFFECTIVE DATE JULY 17, 2012 & JUNE 9, 2014, RESPECTIVELY.

EXISTING CONDITIONS PLAN IN MILTON, MA (NORFOLK COUNTY)

SCALE: 1" = 20' DATE: FEBRUARY 26, 2021

REVISED: JULY 6, 2021


Precision Land Surveying, Inc.

32 Turnpike Road

Southborough, Massachusetts 01772

TELE NO.: (508) 460-1789 FAX NO.: (508) 970-0096

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LEGEND

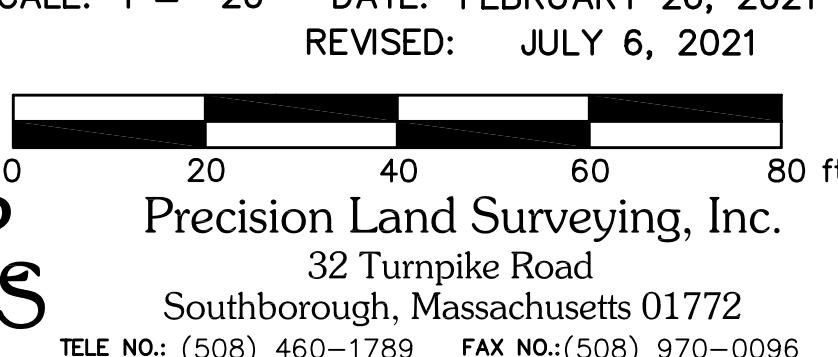
PROPERTY LINE
SILT SOX
PROPOSED PROPERTY LINE
CATCH BASIN SILT SACK
CONSTRUCTION ENTRANCE
LIMIT OF WORK LINE
EXISTING TREE TO BE PROTECTED DURING EXCAVATION TO BE CLEARED AND GRADED
EXISTING PAVEMENT, CURBING AND SIGNS TO BE REMOVED AND DISPOSED OF
BIT. CONC. PAVEMENT REMOVAL
8' CONSTRUCTION FENCE
CONSTRUCTION ENTRANCE

SITE PREPARATION NOTES

- EXISTING CONDITIONS INFORMATION IS REPRODUCED FROM THE SURVEY PREPARED BY PRECISION LAND SURVEY OF WESTBOROUGH, MA AND IS DATED 26 FEBRUARY 2021.
- WITHIN THE LIMIT OF THE WORK LINE AS NOTED ON THE SITE PREPARATION PLANS, REMOVE AND DISCARD ALL CONCRETE PAVEMENT, BITUMINOUS CONCRETE PAVEMENT, BRICK PAVEMENT, TOP SOIL, MULCH, TRASH, DEAD TREES AND STUMPS, SHRUBBERY, CHAIN LINK FENCE POSTS, RAILS, FABRIC, GATES, FOOTINGS AND ALL APPURTENANCES, BOLLARDS, POSTS, CONCRETE FOOTINGS AND FOUNDATIONS, WALLS AND CURES UNLESS OTHERWISE NOTED.
- THE OWNER'S REPRESENTATIVE SHALL BE CONSULTED AND WILL REVIEW THE WORK ON SITE WITH THE CONTRACTOR BEFORE ANY WORK SHALL COMMENCE.
- THE CONTRACTOR SHALL VERIFY ALL EXISTING CONDITIONS IN THE FIELD AND REPORT ANY DISCREPANCIES BETWEEN PLANS AND ACTUAL CONDITIONS TO THE OWNER'S REPRESENTATIVE PRIOR TO STARTING WORK.
- THE CONTRACTOR IS RESPONSIBLE FOR ANY DAMAGE TO EXISTING CONDITIONS TO REMAIN THAT ARE DUE TO CONTRACTOR OPERATIONS.
- ALL ITEMS TO BE REMOVED THAT ARE NOT STOCKPILED FOR LATER REUSE ON THE PROJECT OR DELIVERED TO THE OWNER SHALL BE LEGALLY DISPOSED OF OFF SITE BY THE CONTRACTOR.
- THE LOCATIONS OF UNDERGROUND UTILITIES SHOWN ON THIS PLAN ARE BASED ON THE SURVEY REFERENCED ABOVE. THE CONTRACTOR SHALL CONTACT DISA/SAFE AND THE PROPER LOCAL AUTHORITIES OR RESPECTIVE UTILITY COMPANIES TO CONFIRM THE LOCATION OF ALL EXISTING UTILITIES BEFORE COMMENCING WORK. ANY DAMAGE DUE TO FAILURE OF THE CONTRACTOR TO CONTACT THE PROPER AUTHORITIES SHALL BE BORNE BY THE CONTRACTOR.
- THE CONTRACTOR SHALL BE RESPONSIBLE FOR COORDINATING HIS EFFORTS OF THE DEMOLITION WITH ALL TRADES.
- THE CONTRACTOR SHALL COORDINATE ALL ADJUSTMENT OR ABANDONMENT OF UTILITIES WITH THE RESPECTIVE UTILITY COMPANY.
- THE CONTRACTOR SHALL MAINTAIN OR ADJUST TO NEW GRADE AS NECESSARY ALL UTILITY AND SITE STRUCTURES SUCH AS LIGHT POLES, SIGN POLES, MAN HOLES, CATCH BASINS, HOLE HANDBLES, WATER AND GAS GATES, HYDRANTS, ETC., FROM MAINTAINED UTILITY AND SITE SYSTEMS UNLESS OTHERWISE NOTED OR DIRECTED BY THE OWNER'S REPRESENTATIVE.

CONSTRUCTION SEQUENCE

- CONSTRUCT TEMPORARY AND PERMANENT EROSION CONTROL FACILITIES. EROSION CONTROL FACILITIES SHALL BE INSTALLED PRIOR TO ANY EARTHMOVING.
- ALL PERMANENT DITCHES AND SWALES ARE TO BE STABILIZED WITH VEGETATION OR RIP-RAP PRIOR TO DIRECTING RUNOFF TO THEM.
- CLEAR CUT, DEMOLISH, AND DISPOSE OF EXISTING SITE ELEMENTS NOT TO REMAIN.
- GRADE AND GRAVEL ALL PAVED AREAS. ALL PROPOSED PAVED AREAS SHALL BE STABILIZED IMMEDIATELY AFTER GRADING.
- BEGIN ALL PERMANENT AND TEMPORARY SEEDING AND MULCHING. ALL CUT AND FILL SLOPES SHALL BE SEEDED AND MULCHED IMMEDIATELY AFTER THEIR CONSTRUCTION.
- DAILY OR AS REQUIRED, CONSTRUCT TEMPORARY BERMS, DRAINS, DITCHES, SILT FENCES; MULCH AND SEED AS REQUIRED.
- FINISH PAVING ALL HARD SURFACE AREAS.
- INSPECT AND MAINTAIN ALL EROSION AND SEDIMENT CONTROL MEASURES.
- COMPLETE PERMANENT SEEDING AND LANDSCAPING.
- REMOVE TEMPORARY EROSION CONTROL MEASURES.
- THE CONSTRUCTION SEQUENCE SHALL BE CONFINED TO THE LIMIT OF GRADING AS SHOWN ON THE DRAWINGS.
- UPON COMPLETION OF CONSTRUCTION THE OWNER SHALL AGREE TO MAINTAIN AND CLEAN ALL DRAINAGE STRUCTURES ON A YEARLY BASIS.

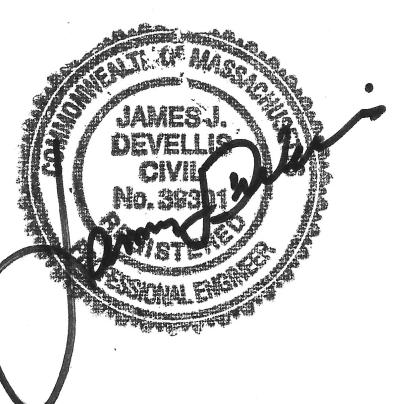

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DZI

DeVellis Zrein Inc.

SITE
PREPARATION
PLAN

SCALE:	1"=20'
JOB:	2G15-455
FILE:	CRM
DRAWN:	JJD
CHECKED:	
DATE:	11-04-22

SP-1

LAYOUT AND MATERIAL NOTES

1. EXISTING CONDITIONS INFORMATION IS REPRODUCED FROM THE SURVEY PREPARED BY PRECISION LAND SURVEY OF WESTBOROUGH, MA AND IS DATED 26 FEBRUARY 2021.
2. THE LOCATIONS OF UNDERGROUND UTILITIES SHOWN ARE BASED ON THE SURVEY REFERENCED ABOVE. THE CONTRACTOR SHALL NOTIFY DIGSAFE AND THE PROPER LOCAL AUTHORITIES OR RESPECTIVE UTILITY COMPANIES TO CONFIRM THE LOCATION OF ALL EXISTING UTILITIES BEFORE COMMENCING WORK. ANY DAMAGE DUE TO FAILURE OF THE CONTRACTOR TO CONTACT THE PROPER AUTHORITIES SHALL BE BORNE BY THE CONTRACTOR.
3. CONTRACTOR(s) SHALL THOROUGHLY FAMILIARIZE THEMSELVES WITH ALL CONSTRUCTION DOCUMENTS, SPECIFICATIONS, AND SITE CONDITIONS PRIOR TO BIDDING AND PRIOR TO CONSTRUCTION.
4. ANY DISCREPANCIES BETWEEN DRAWINGS, SPECIFICATIONS, AND SITE CONDITIONS SHALL BE REPORTED IMMEDIATELY TO THE OWNER'S REPRESENTATIVE FOR CLARIFICATION AND RESOLUTION PRIOR TO BIDDING OR CONSTRUCTION.
5. ALL WORK CONDUCTED WITHIN PUBLIC RIGHT-OF-WAYS SHALL CONFORM TO THE REQUIREMENTS AND SPECIFICATIONS OF THE CITY OF XXXXX AND THE XXXXX HIGHWAY DEPARTMENT.
6. SEE ARCHITECTURAL DRAWINGS FOR EXACT BUILDING DIMENSIONS AND ALL DETAILS CONTIGUOUS TO THE BUILDING, INCLUDING SIDEWALKS, RAMPS, UTILITY ENTRANCE LOCATIONS, WALL PACKS, CONCRETE DOOR PADS, ROOF DRAINS, ETC.
7. ACCESSIBLE CURB RAMPS SHALL BE PER THE MASSACHUSETTS ARCHITECTURAL ACCESS BOARD (AAB) AND THE AMERICANS WITH DISABILITIES ACT (ADA) ACCESSIBILITY GUIDELINES, WHICHEVER IS MORE STRINGENT.
8. THE FOLLOWING LAYOUT CRITERIA SHALL CONTROL UNLESS OTHERWISE NOTED ON THE PLAN:
ALL DIMENSIONS ARE TO OUTSIDE FACE OF BUILDING.
ALL DIMENSIONS ARE TO FACE OF CURB AT GUTTER LINE.
ALL DIMENSIONS ARE TO CENTER OF PAVEMENT MARKINGS.
ALL TIES TO PROPERTY LINES ARE PERPENDICULAR TO THE PROPERTY LINE UNLESS OTHERWISE NOTED.
9. FOR LAYOUT AND DIMENSIONING OF BUILDINGS, SEE ARCHITECTURAL DRAWINGS.
10. SCREENED IMAGES SHOW EXISTING CONDITIONS. WHERE EXISTING CONDITIONS LIE UNDER OR ARE IMPINGED UPON BY PROPOSED BUILDINGS AND/OR SITE ELEMENTS, THE EXISTING CONDITION WILL BE REMOVED, ABANDONED AND/OR CAPPED OR DEMOLISHED AS REQUIRED.

LEGEND

PROPERTY LINE

SITE LIGHTING

CEMENT CONCRETE PAVEMENT

VGC

BCC

ICC



FC

SILT SOXX



LAYOUT AND MATERIALS PLAN

1"=20'
2G1S-455
CRM
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JJD
11-04-22

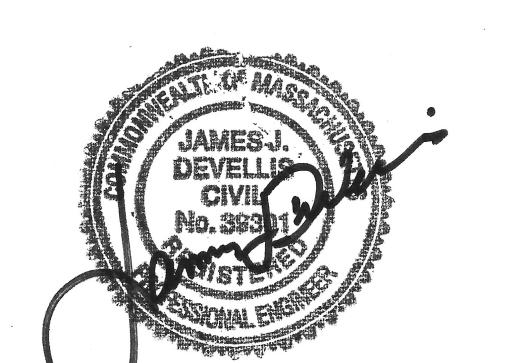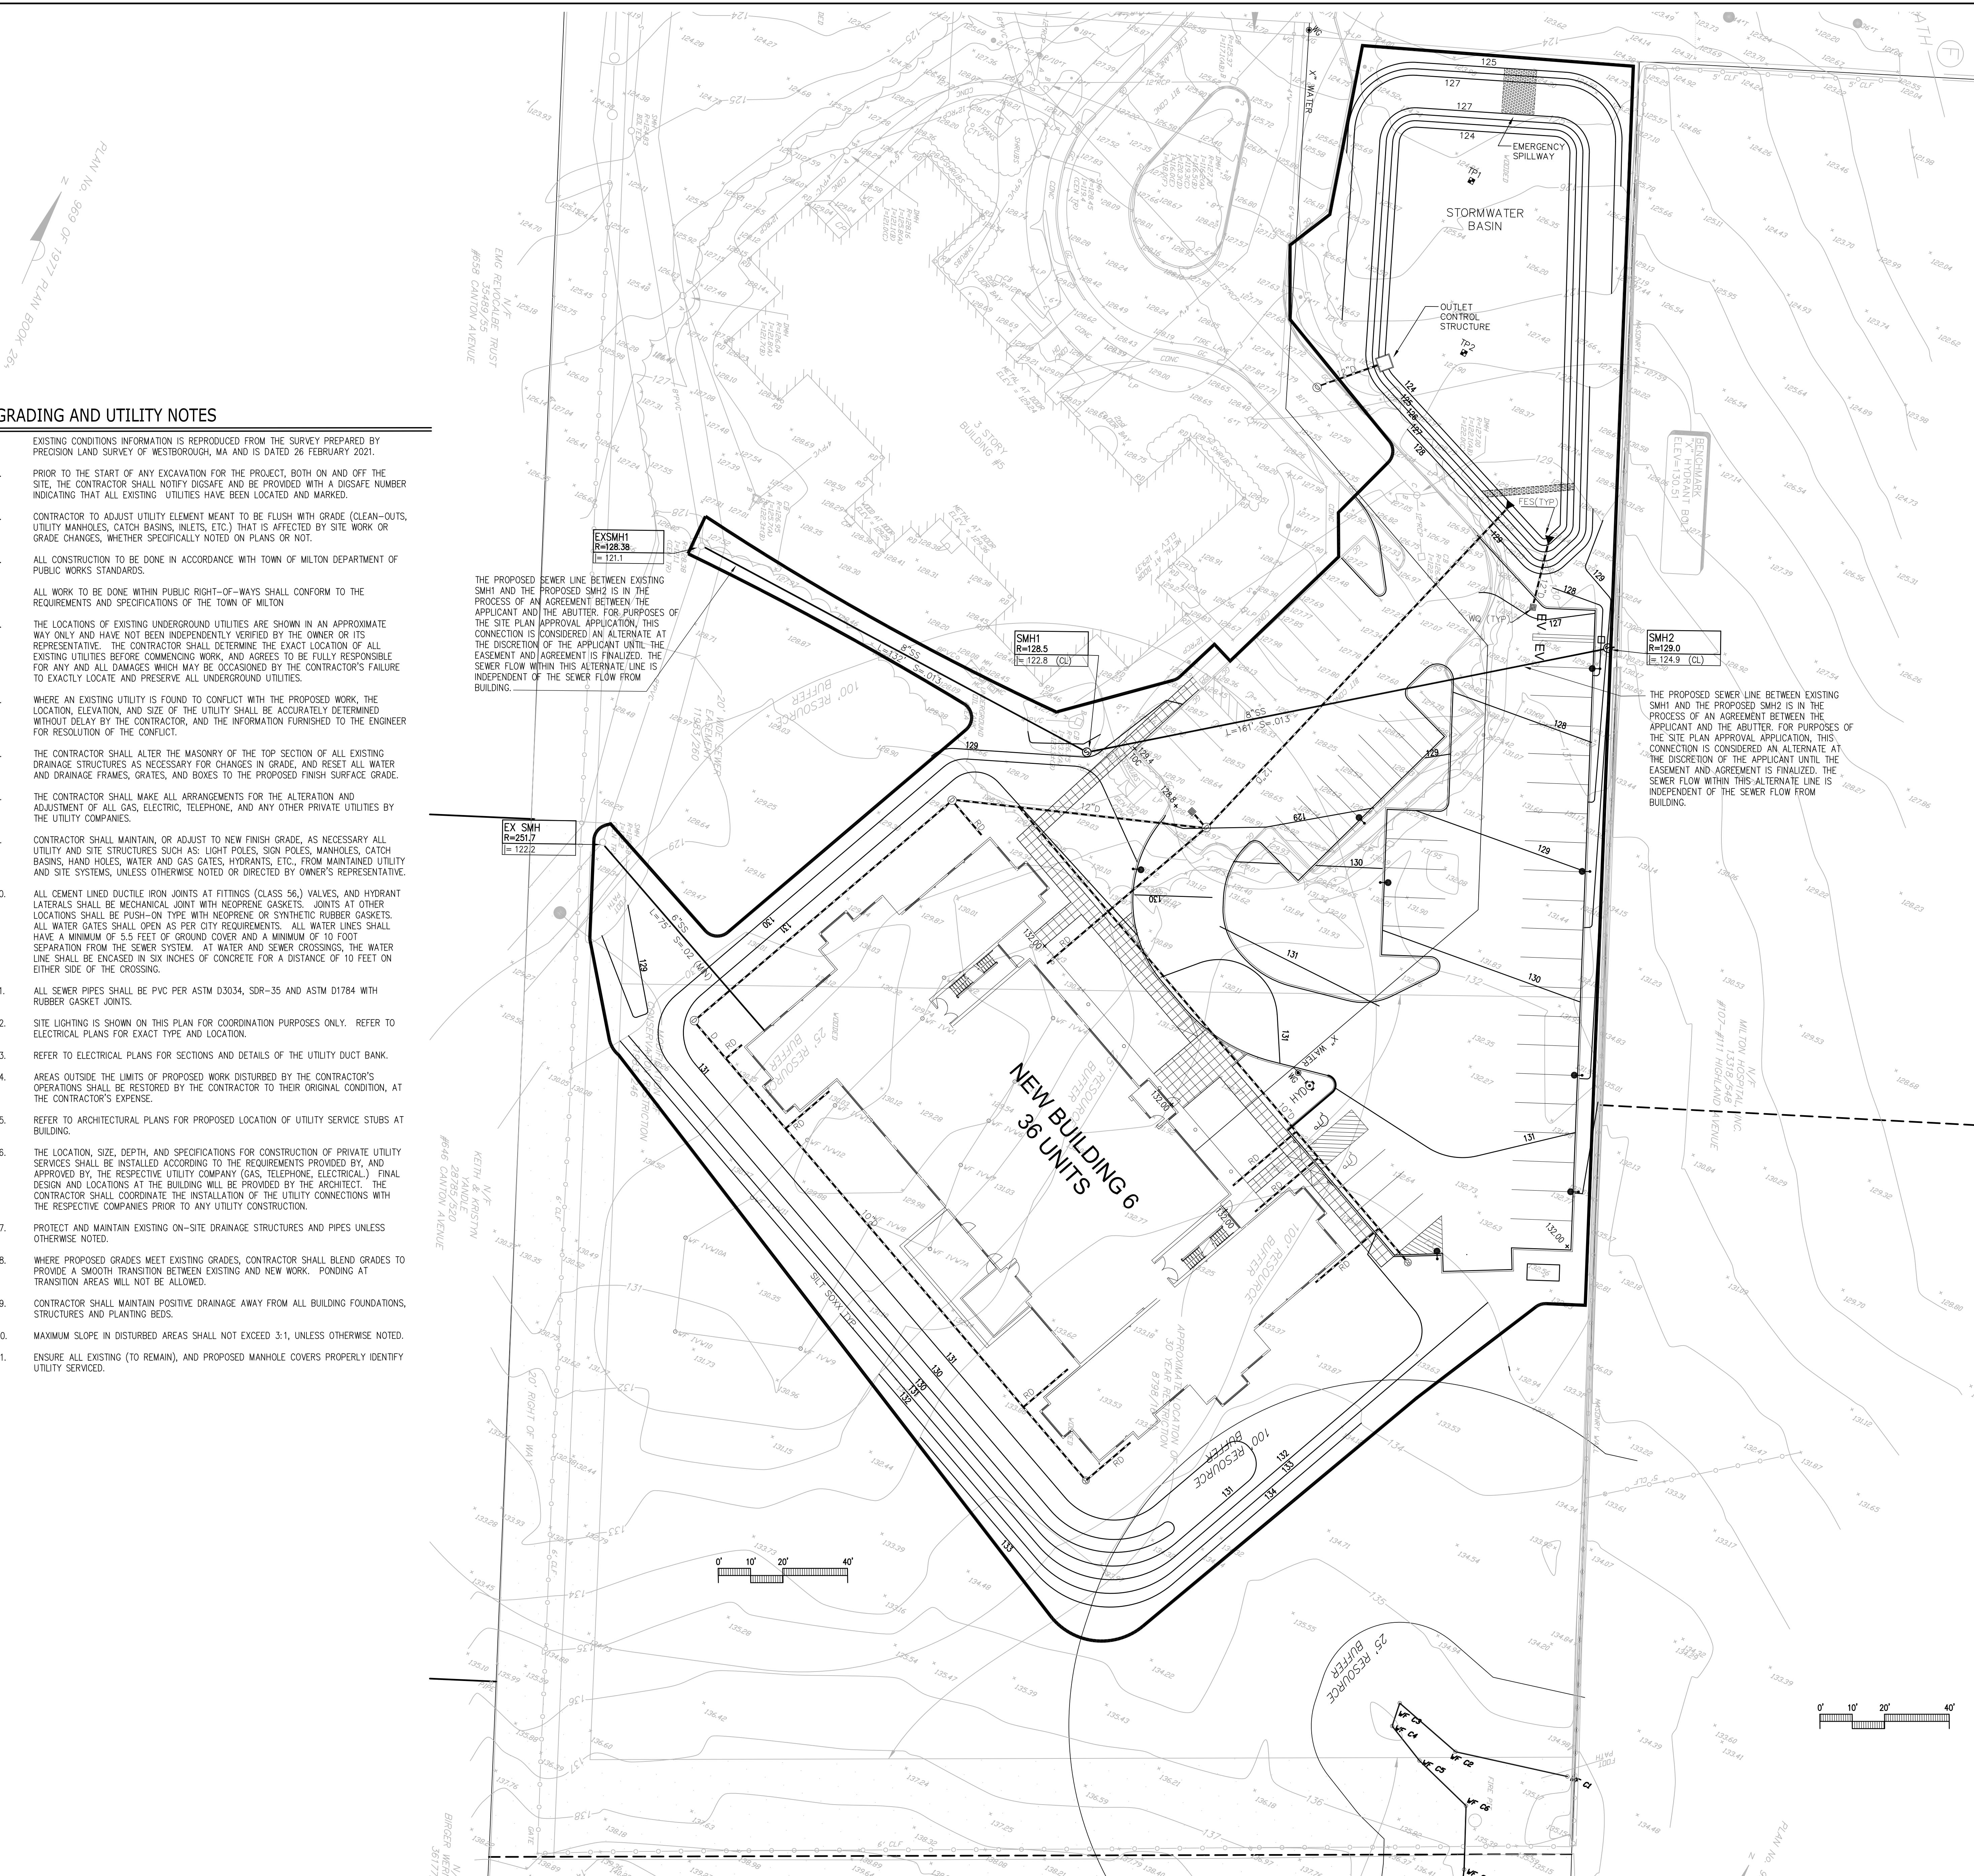


DZI
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GRADING AND UTILITIES
PLAN

SCALE: 1"=20'
JOB: 2G15-455
FILE: 2G15-455-04
DRAWN: CRM
CHECKED: JD
DATE: 11-04-22



PLANTING NOTES

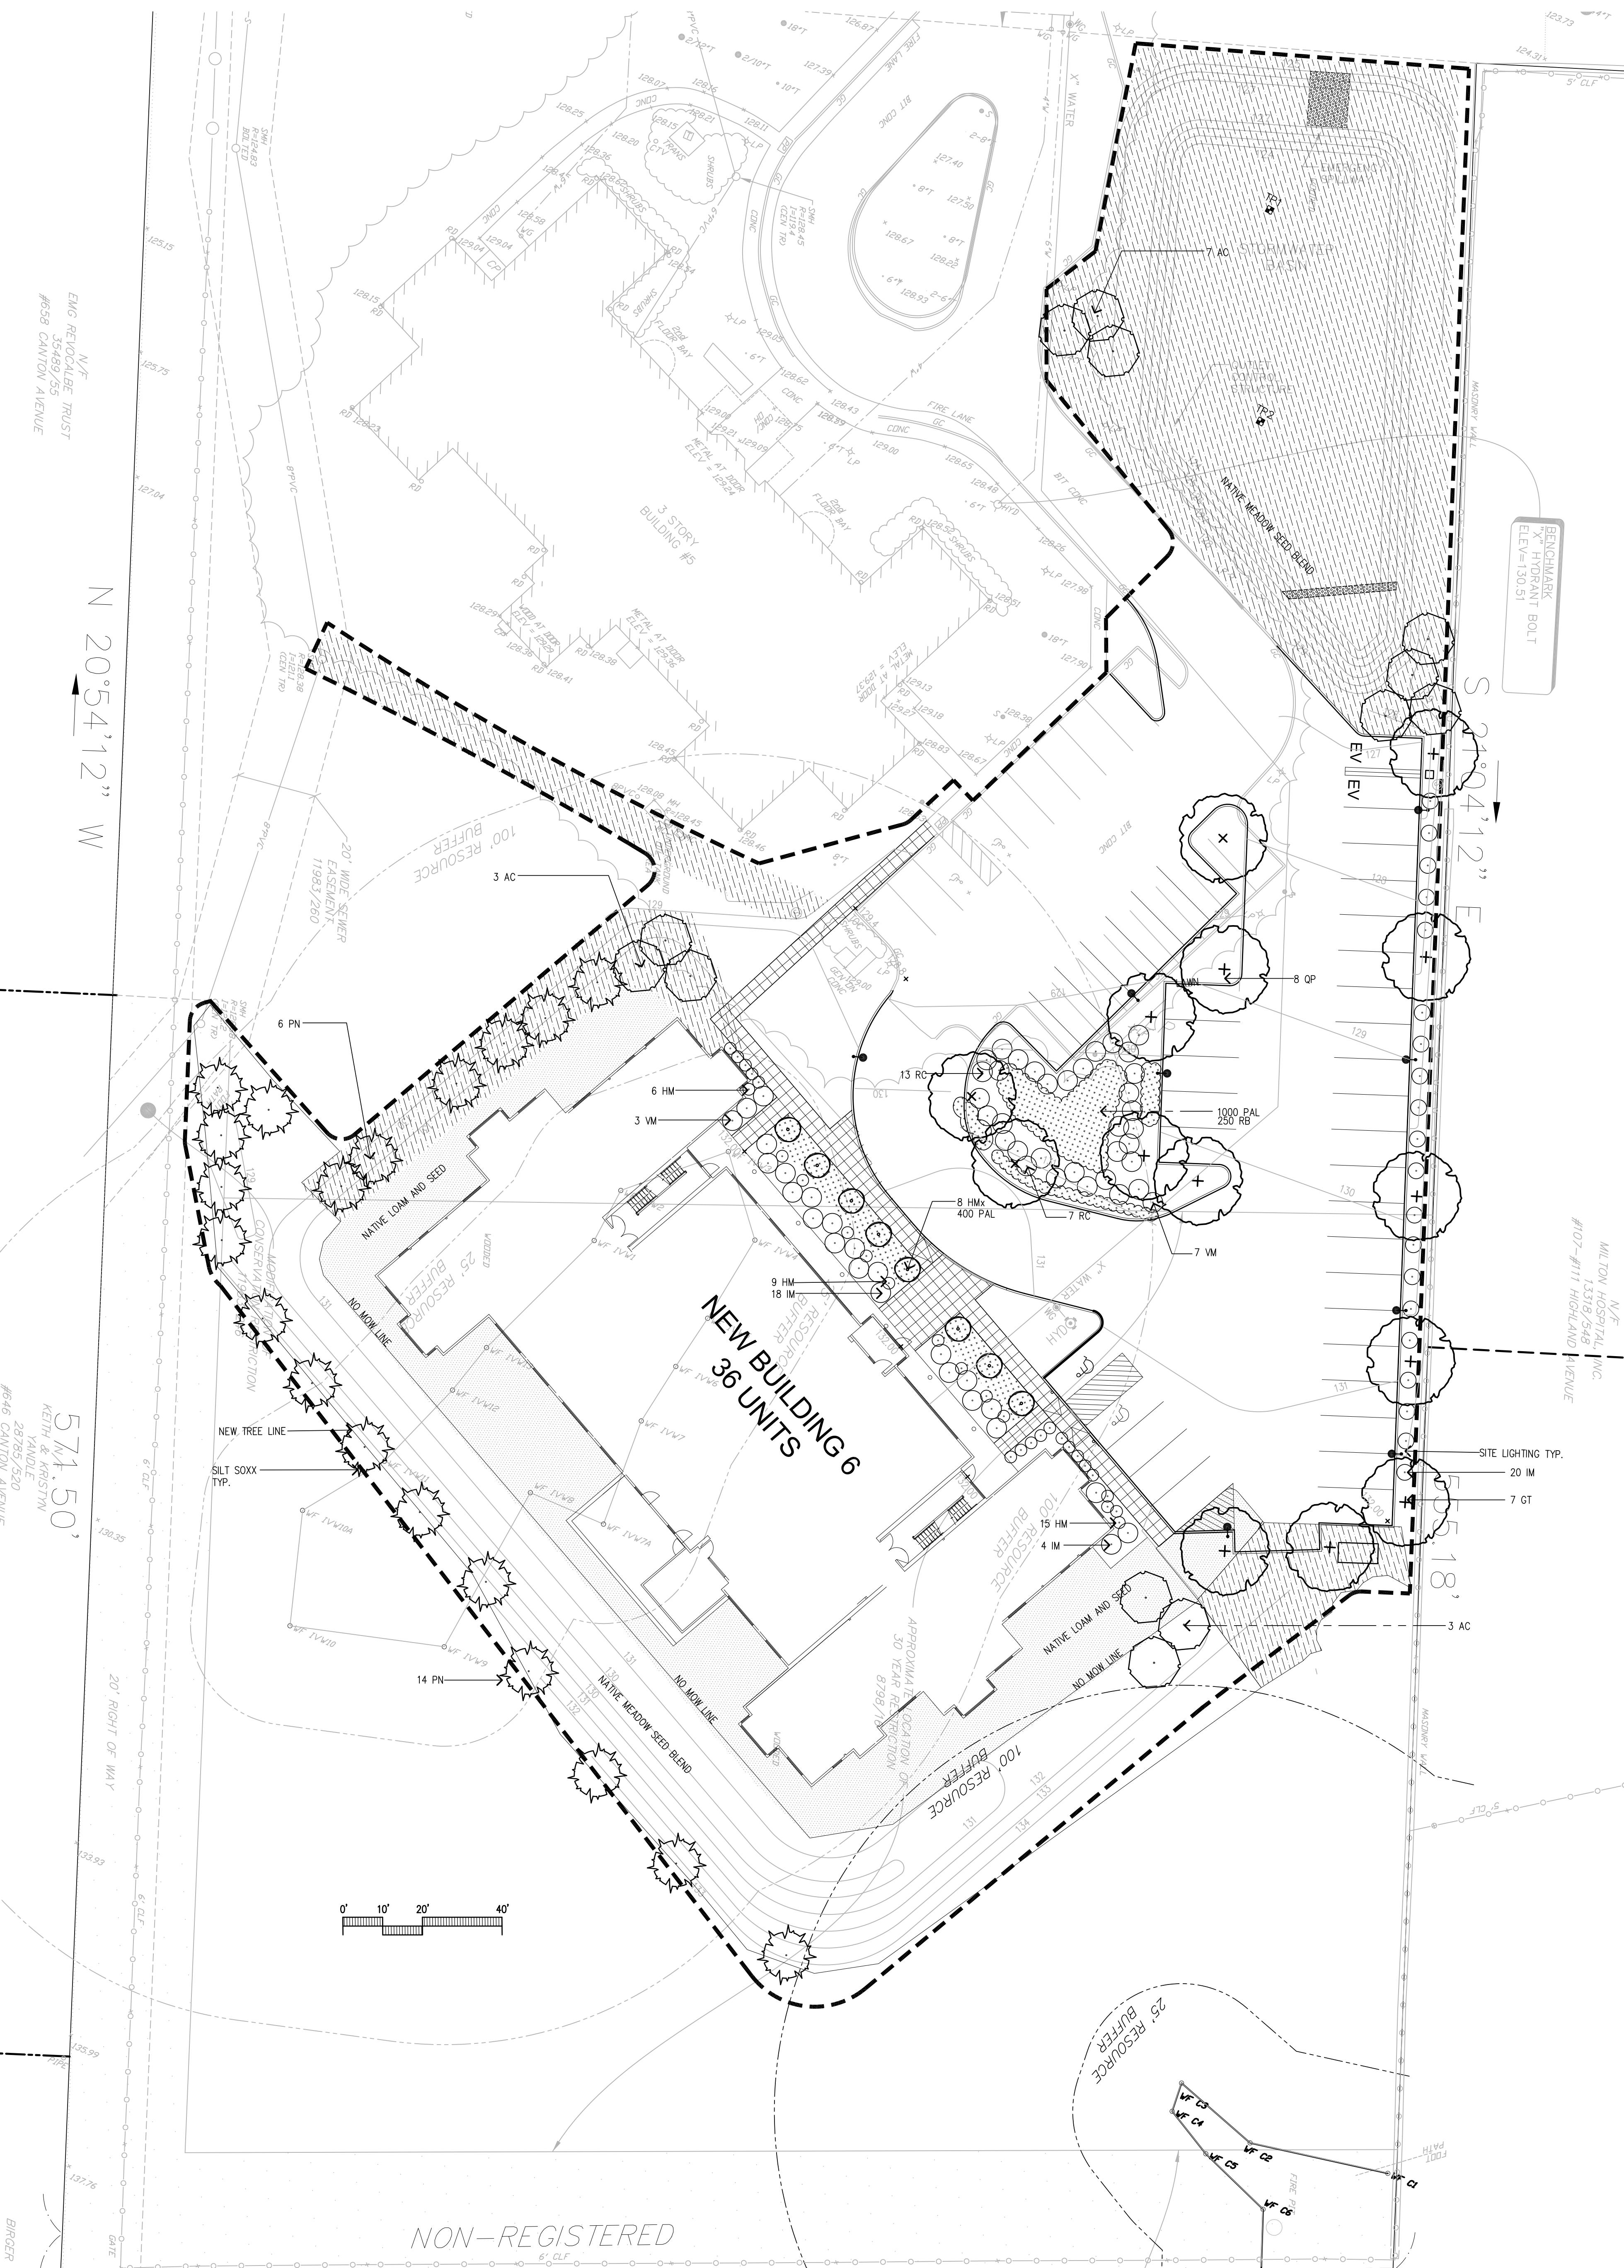
- EXISTING CONDITIONS INFORMATION IS REPRODUCED FROM THE SURVEY PREPARED BY PLS OF SOUTHBOROUGH MA AND IS DATED FEBRUARY 26, 2021
- THE LOCATIONS OF UNDERGROUND UTILITIES SHOWN ARE BASED ON THE SURVEYS PROVIDED ABOVE. THE CONTRACTOR SHALL CONTACT DISAGUE AND THE PROPER LOCAL AUTHORITY TO REQUEST UTILITY COMPANIES TO CONFIRM THE LOCATION OF ALL EXISTING UTILITIES BEFORE COMMENCING WORK. ANY DAMAGE DUE TO FAILURE OF THE CONTRACTOR TO CONTACT THE PROPER AUTHORITIES SHALL BE BORNE BY THE CONTRACTOR.
- CONTRACTOR SHALL BEGIN MAINTENANCE IMMEDIATELY AFTER PLANTING AND WILL CONTINUE UNTIL FINAL WRITTEN ACCEPTANCE OF PLANT MATERIAL.
- LANDSCAPE ARCHITECT TO FLAG ALL TREES TO BE TRANSPLANTED PRIOR TO CONSTRUCTION START.
- CONTRACTOR SHALL VERIFY ALL TREE REMOVALS AND/OR TRANSPLANTS WITH OWNER'S REPRESENTATIVE PRIOR TO CONSTRUCTION START.
- CONTRACTOR SHALL MAINTAIN POSITIVE DRAINAGE AWAY FROM ALL BUILDING FOUNDATIONS, STRUCTURES, AND PLANTING BEDS.
- MAXIMUM SLOPE WITHIN DISTURBED AREAS SHALL NOT EXCEED 3:1, UNLESS OTHERWISE NOTED.
- THE LANDSCAPE CONTRACTOR SHALL SUPPLY ALL PLANT MATERIALS IN QUANTITIES SUFFICIENT TO COMPLETE ALL PLANTINGS SHOWN ON THIS DRAWING.
- ALL MATERIALS SHALL CONFORM TO THE GUIDELINES ESTABLISHED BY THE AMERICAN NURSERY AND LANDSCAPE ASSOCIATION.
- ALL PLANTS SHALL BEAR THE SAME RELATIONSHIP TO FINISH GRADE AS TO ORIGINAL GRADE BEFORE DIGGING.
- ALL PLANTS TO BE BALLED IN BURLAP OR CONTAINERIZED.
- MULCH FOR PLANTED AREAS TO BE AGED PINE BARK, PARTIALLY DECOMPOSED, DARK BROWN IN COLOR AND FREE OF WOOD CHIPS, THICKER THAN 1/4 INCH.
- PLANTING SOIL MIX: LOAM THOROUGHLY INCORPORATED WITH ROTTED MANURE PROPORTIONED 5 C.Y. TO 1 C.Y. OR EQUIVALENT. FERTILIZER ADDED PER RECOMMENDED RATES OF SOILS ANALYSIS.
- THE LANDSCAPE CONTRACTOR SHALL GUARANTEE ALL PLANT MATERIALS FOR ONE (1) FULL YEAR FROM DATE OF ACCEPTANCE.
- ALL PLANT MATERIALS ARE SUBJECT TO THE APPROVAL OF THE LANDSCAPE ARCHITECT, AT THE NURSERY, AND AT THE SITE.

PLANT SCHEDULE

SYMBOL	BOTANICAL NAME	COMMON NAME	QTY	SIZE	COMMENT
GT	CLEDTISIA TRICANTHOS 'SHADEMASTER'	SHADE MASTER HONEY LOCUST	7	3-3.5" CAL.	
OP	QUERCUS PALUSTRIS	PIN OAK	7	3-3.5" CAL.	
EVERGREEN TREES	PN	PINUS NIGRA	20	6-7" HT.	
ORNAMENTAL TREES AND SHRUBS	AC	AMELANCHIER CANADENSIS	13	6-7" HT.	
	HM	HYDRANGEA PANICULATA 'BOBO'	30	24-36" HT.	
	IM	ILEX MESERIAE 'BLUE PRINCESS'	42	24-36" HT.	
	RC	RHODODENDRON CHINOIDES	20	24-36" HT.	
	VM	VIBURNUM OPULUS	10	24-36" HT.	
PERENNIALS	PAL	PANICUM VIRGATUM	1450	4" POT	
	RB	RUDBECKIA GOLDSTRUM	250	1 GAL.	

SEED BLEND FOR BASIN
SUPPLEMENT PLANTINGS IN RAIN GARDEN WITH THE FOLLOWING SEED BLEND:
New England Wetland Plants, Inc.
New England Erosion Control/Restoration Mix For Detention Basins and Moist Sites
1LB OF SEED FOR THE ENTIRE RAIN GARDEN/APPLICATION TIME LATE SPRING/SUMMER.

NATIVE SEED BLEND
30% HARD FESCUE
25% PER. RYE
25% LITTLE BLUESTEM
20% SWITCHGRASS

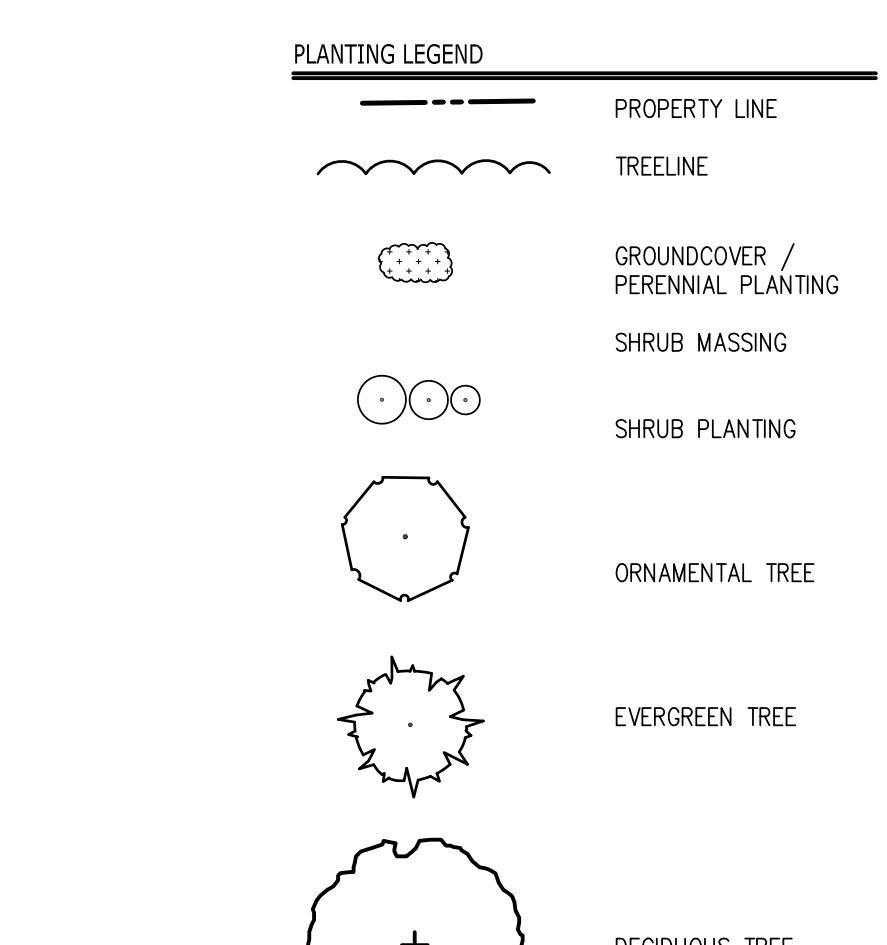

DECIDUOUS TREE

EVERGREEN TREE

ORNAMENTAL TREE

SHRUB PLANTING

GROUNDCOVER / PERENNIAL PLANTING

TREELINE

PROPERTY LINE

+

DECIDUOUS TREE

+

EVERGREEN TREE

SHRUB PLANTING

GROUNDCOVER / PERENNIAL PLANTING

TREELINE

PROPERTY LINE

+

DECIDUOUS TREE

+

EVERGREEN TREE

SHRUB PLANTING

GROUNDCOVER / PERENNIAL PLANTING

TREELINE

PROPERTY LINE

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DECIDUOUS TREE

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EVERGREEN TREE

SHRUB PLANTING

GROUNDCOVER / PERENNIAL PLANTING

TREELINE

PROPERTY LINE

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DECIDUOUS TREE

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EVERGREEN TREE

SHRUB PLANTING

GROUNDCOVER / PERENNIAL PLANTING

TREELINE

PROPERTY LINE

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DECIDUOUS TREE

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EVERGREEN TREE

SHRUB PLANTING

GROUNDCOVER / PERENNIAL PLANTING

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DECIDUOUS TREE

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EVERGREEN TREE

SHRUB PLANTING

GROUNDCOVER / PERENNIAL PLANTING

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PROPERTY LINE

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DECIDUOUS TREE

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EVERGREEN TREE

SHRUB PLANTING

GROUNDCOVER / PERENNIAL PLANTING

TREELINE

PROPERTY LINE

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DECIDUOUS TREE

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EVERGREEN TREE

SHRUB PLANTING


GROUNDCOVER / PERENNIAL PLANTING

TREELINE


PROPERTY LINE

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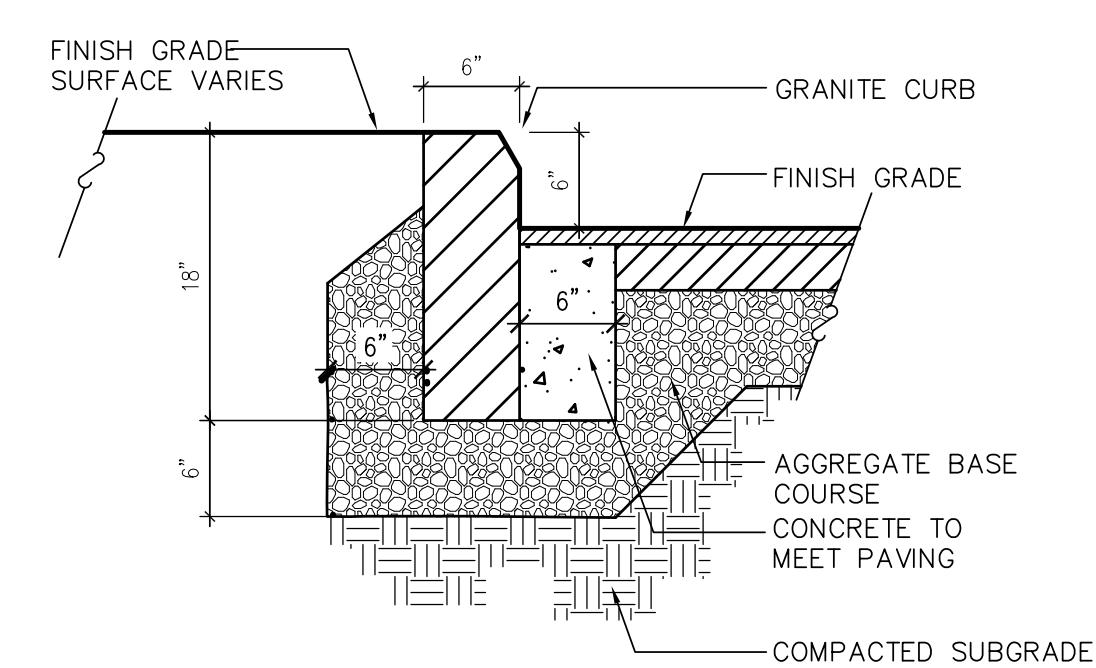
DECIDUOUS TREE

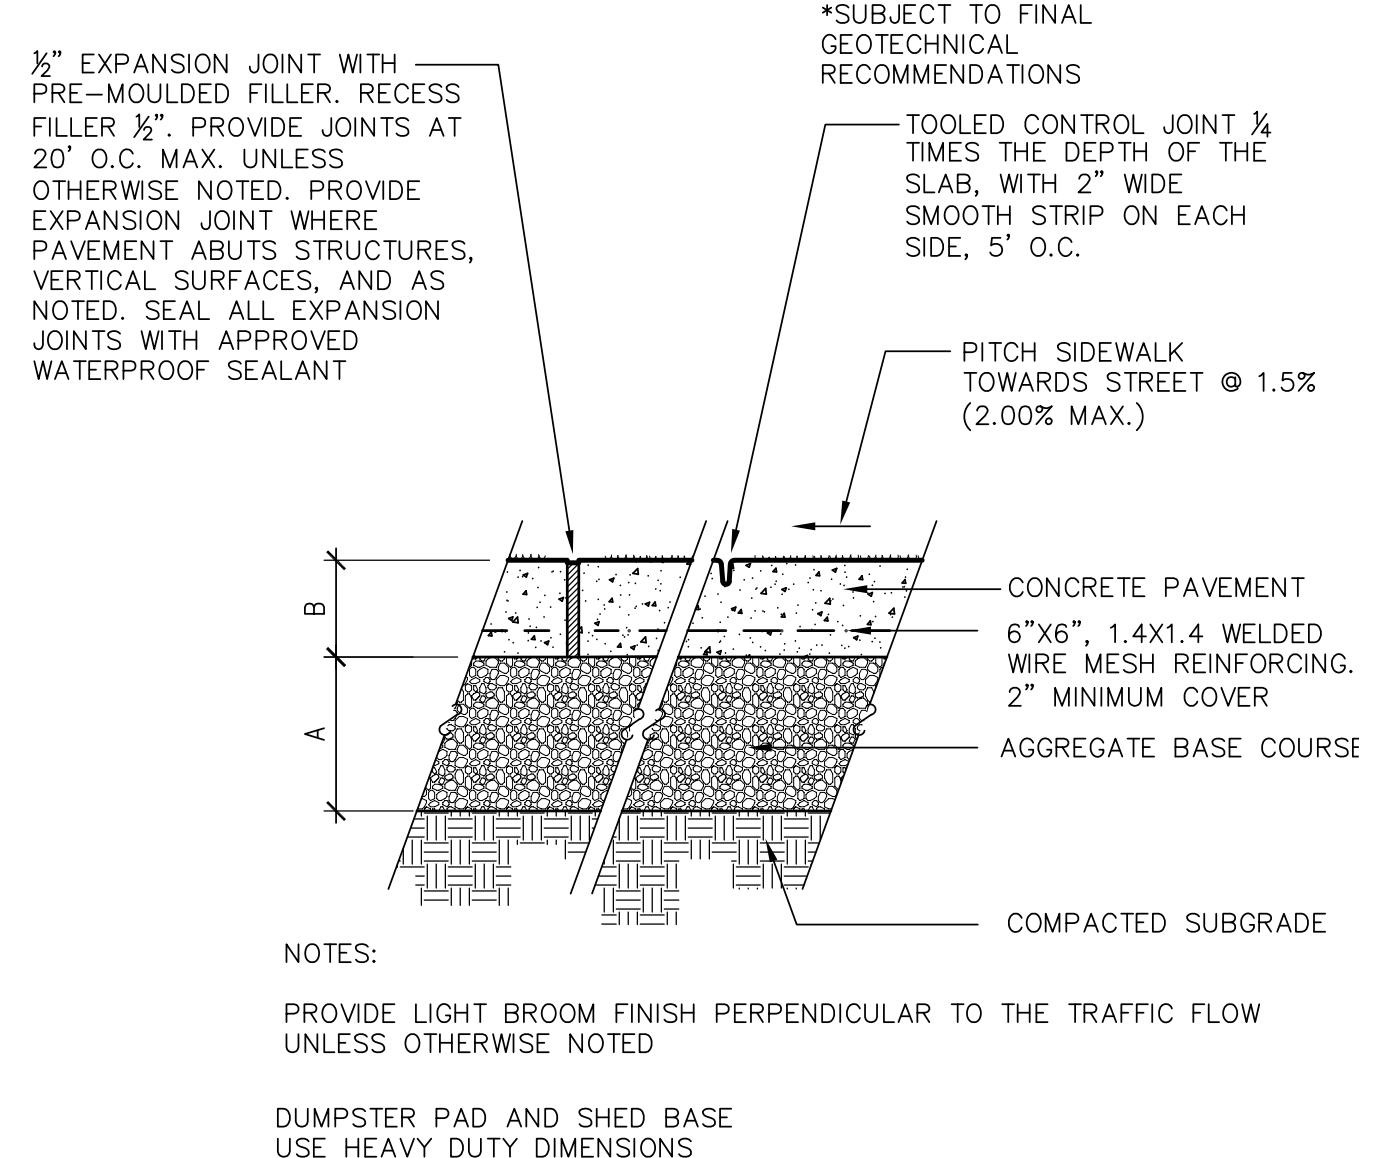


CEMENT CONCRETE SIDEWALK

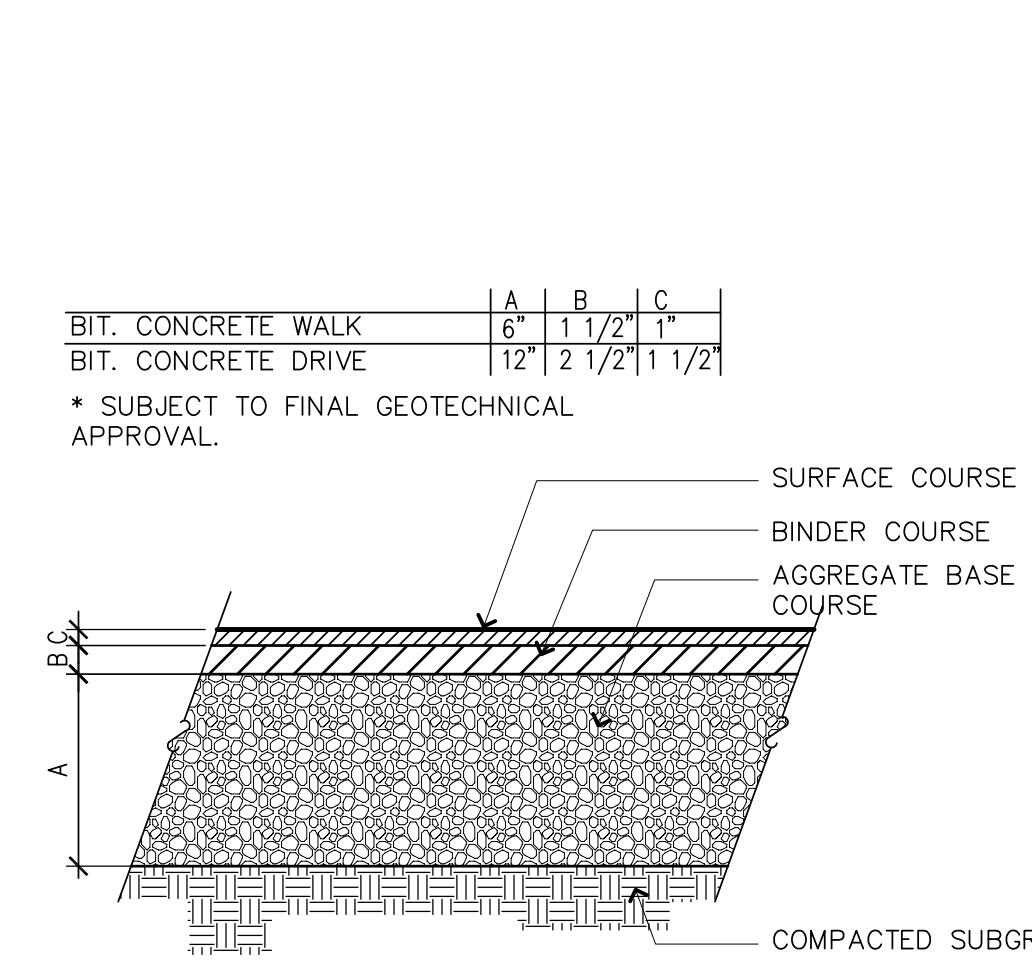


BITUMINOUS CONCRETE PAVEMENT




VERTICAL GRANITE CURB

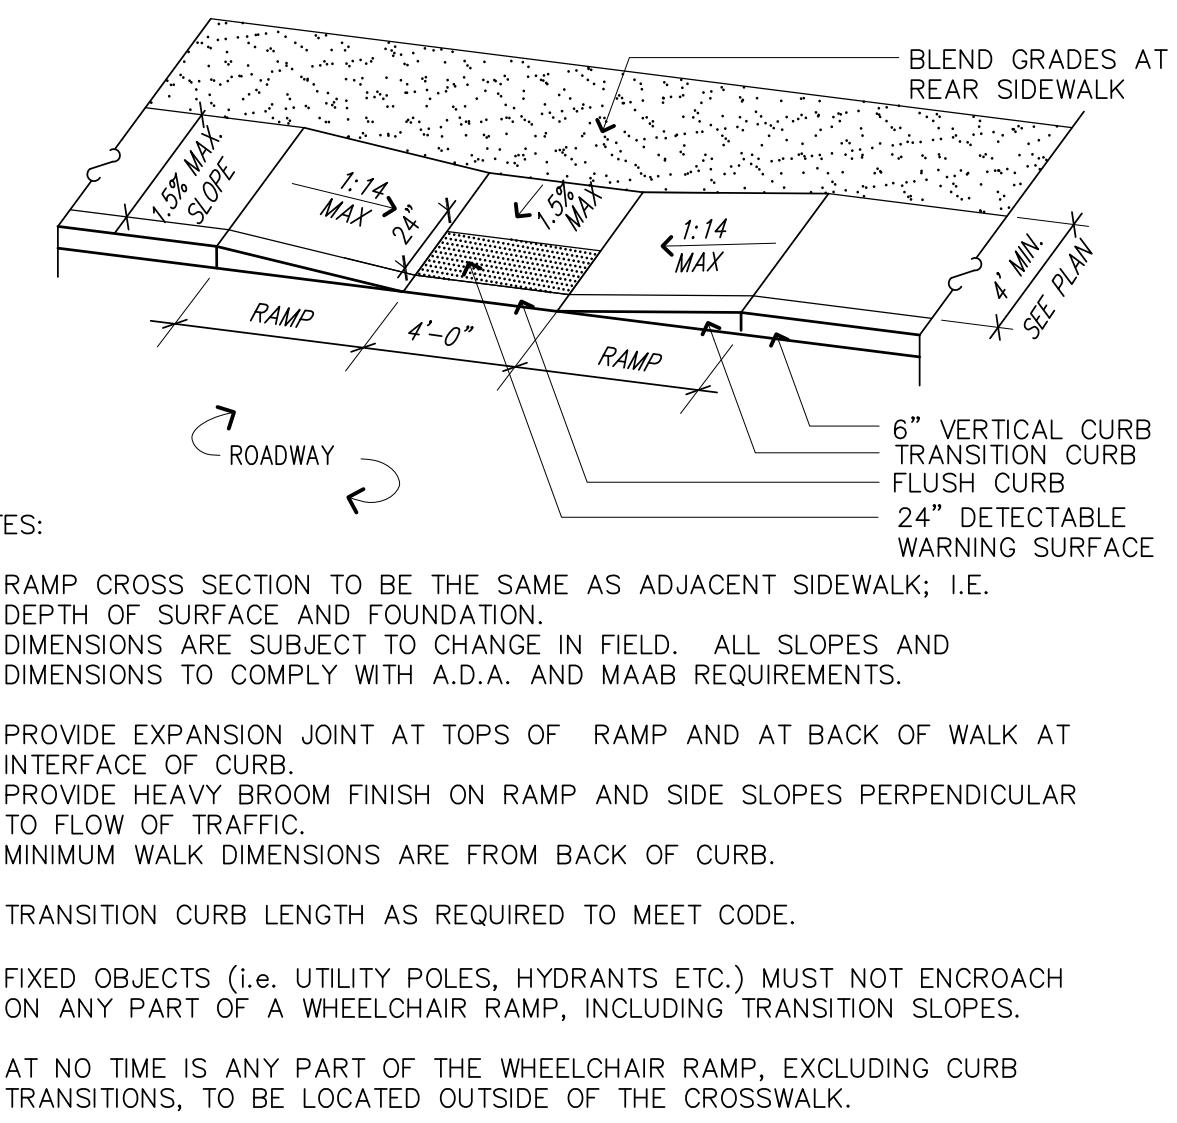


CURB CUT TYPE 'A'

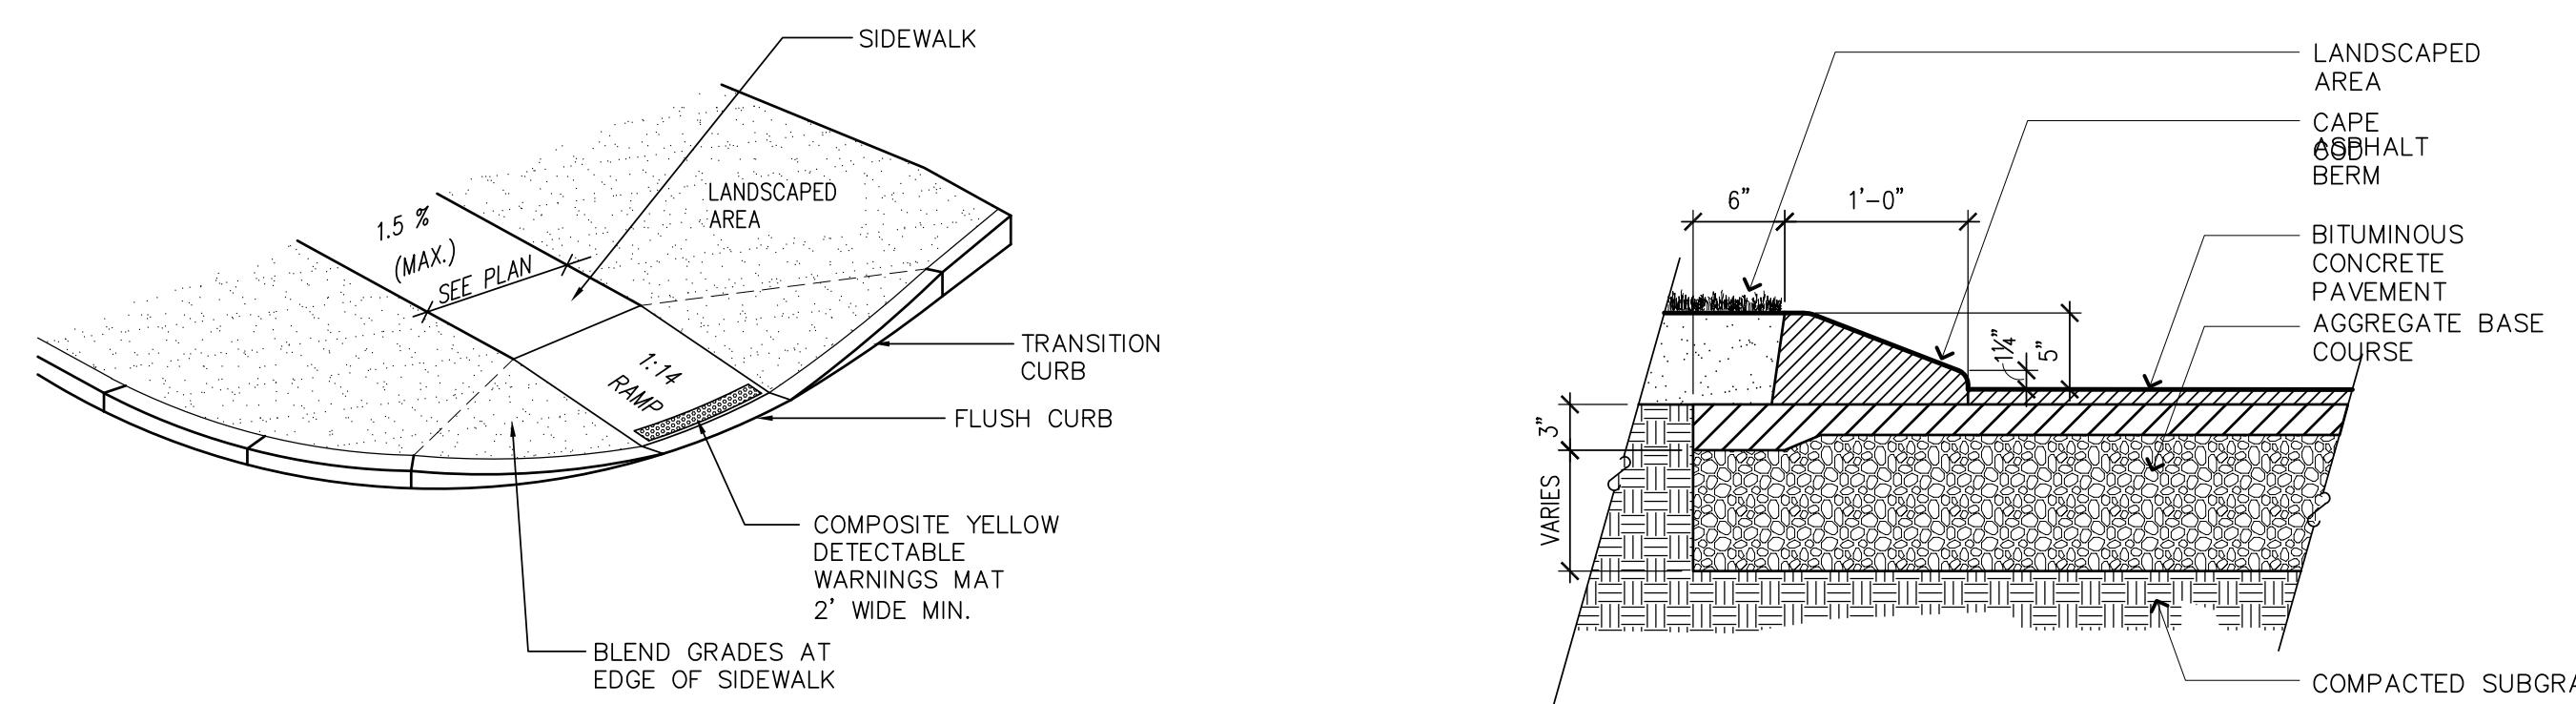


HANDICAP CURB CUT TYPE 'B'

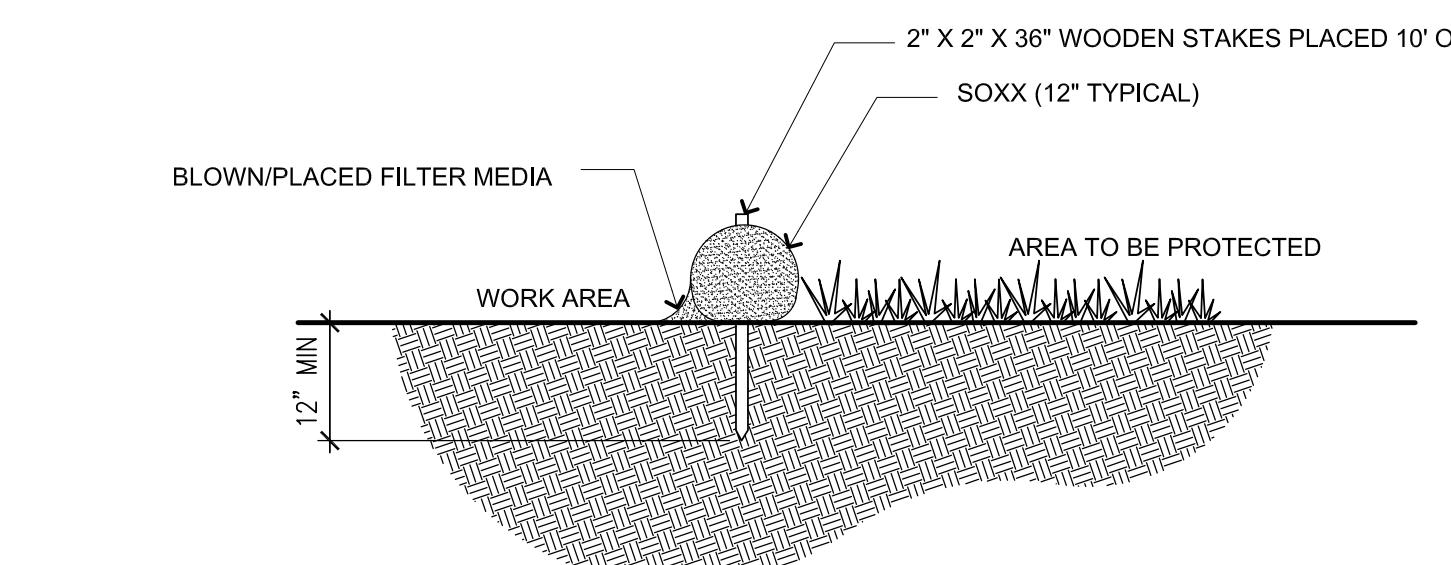


CAPE COD BERM

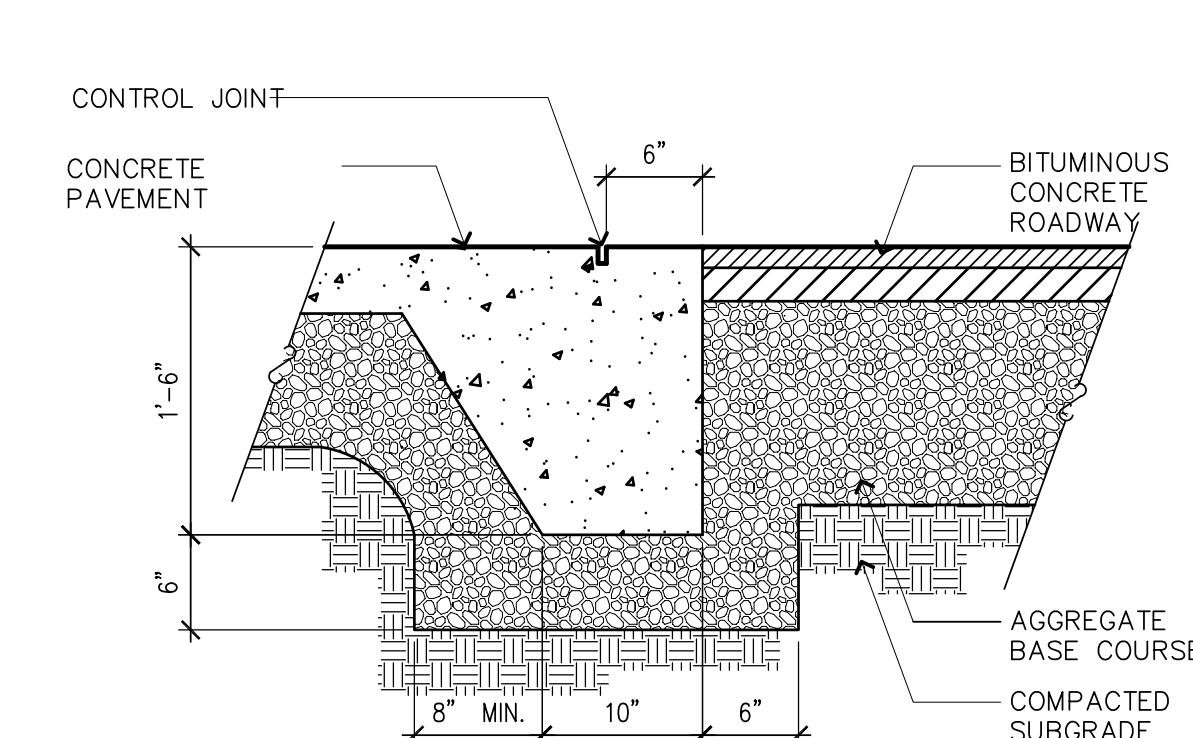

INTREGAL CONCRETE CURB

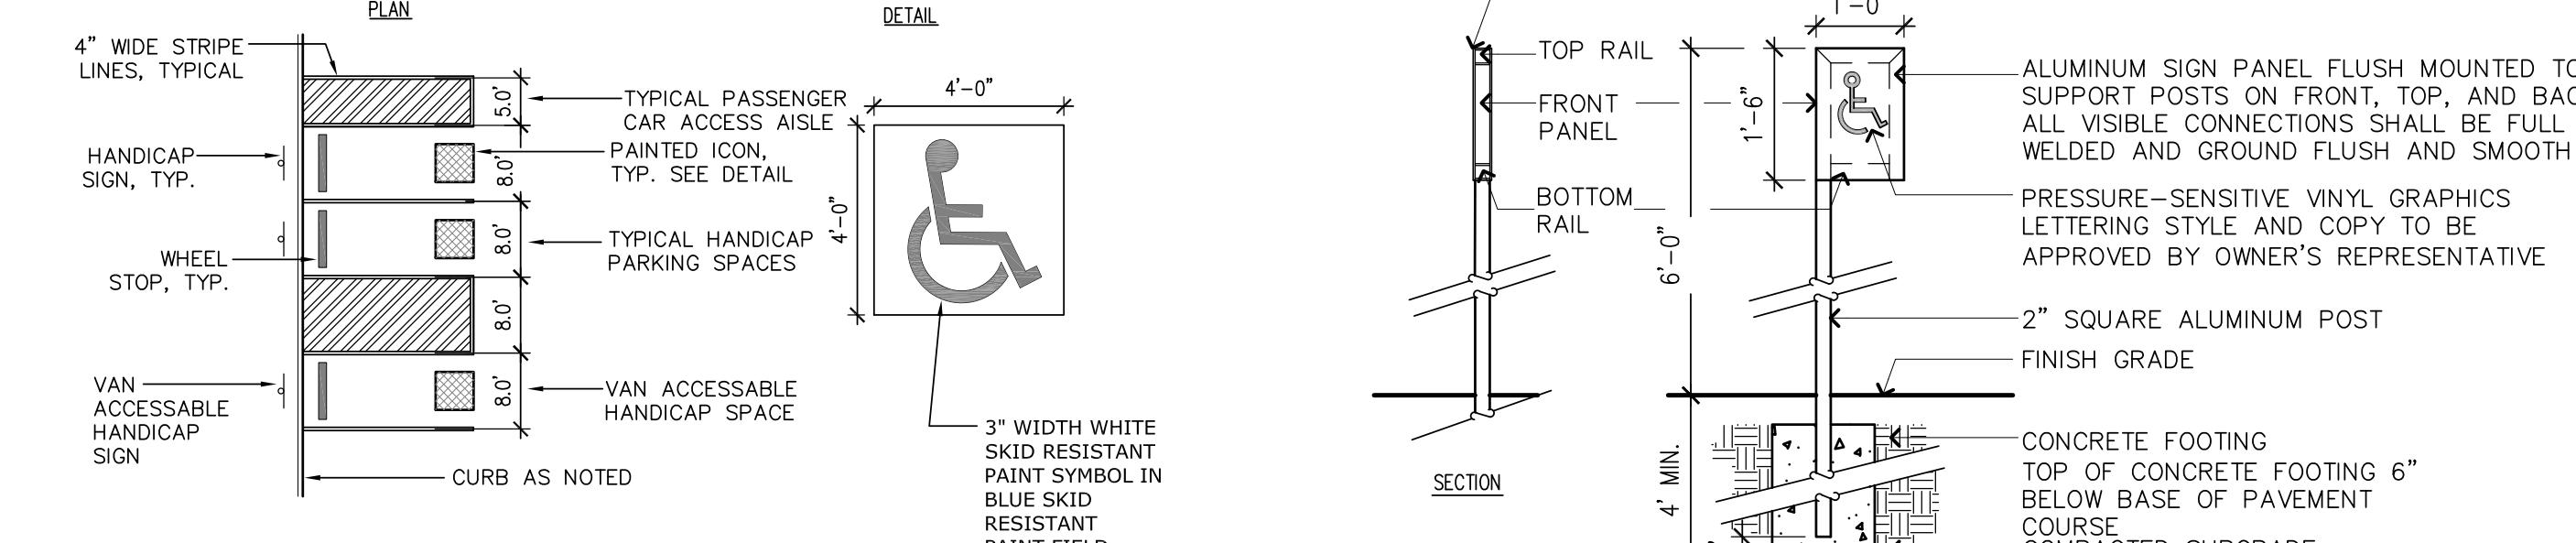



HANDICAP PARKING LAYOUT

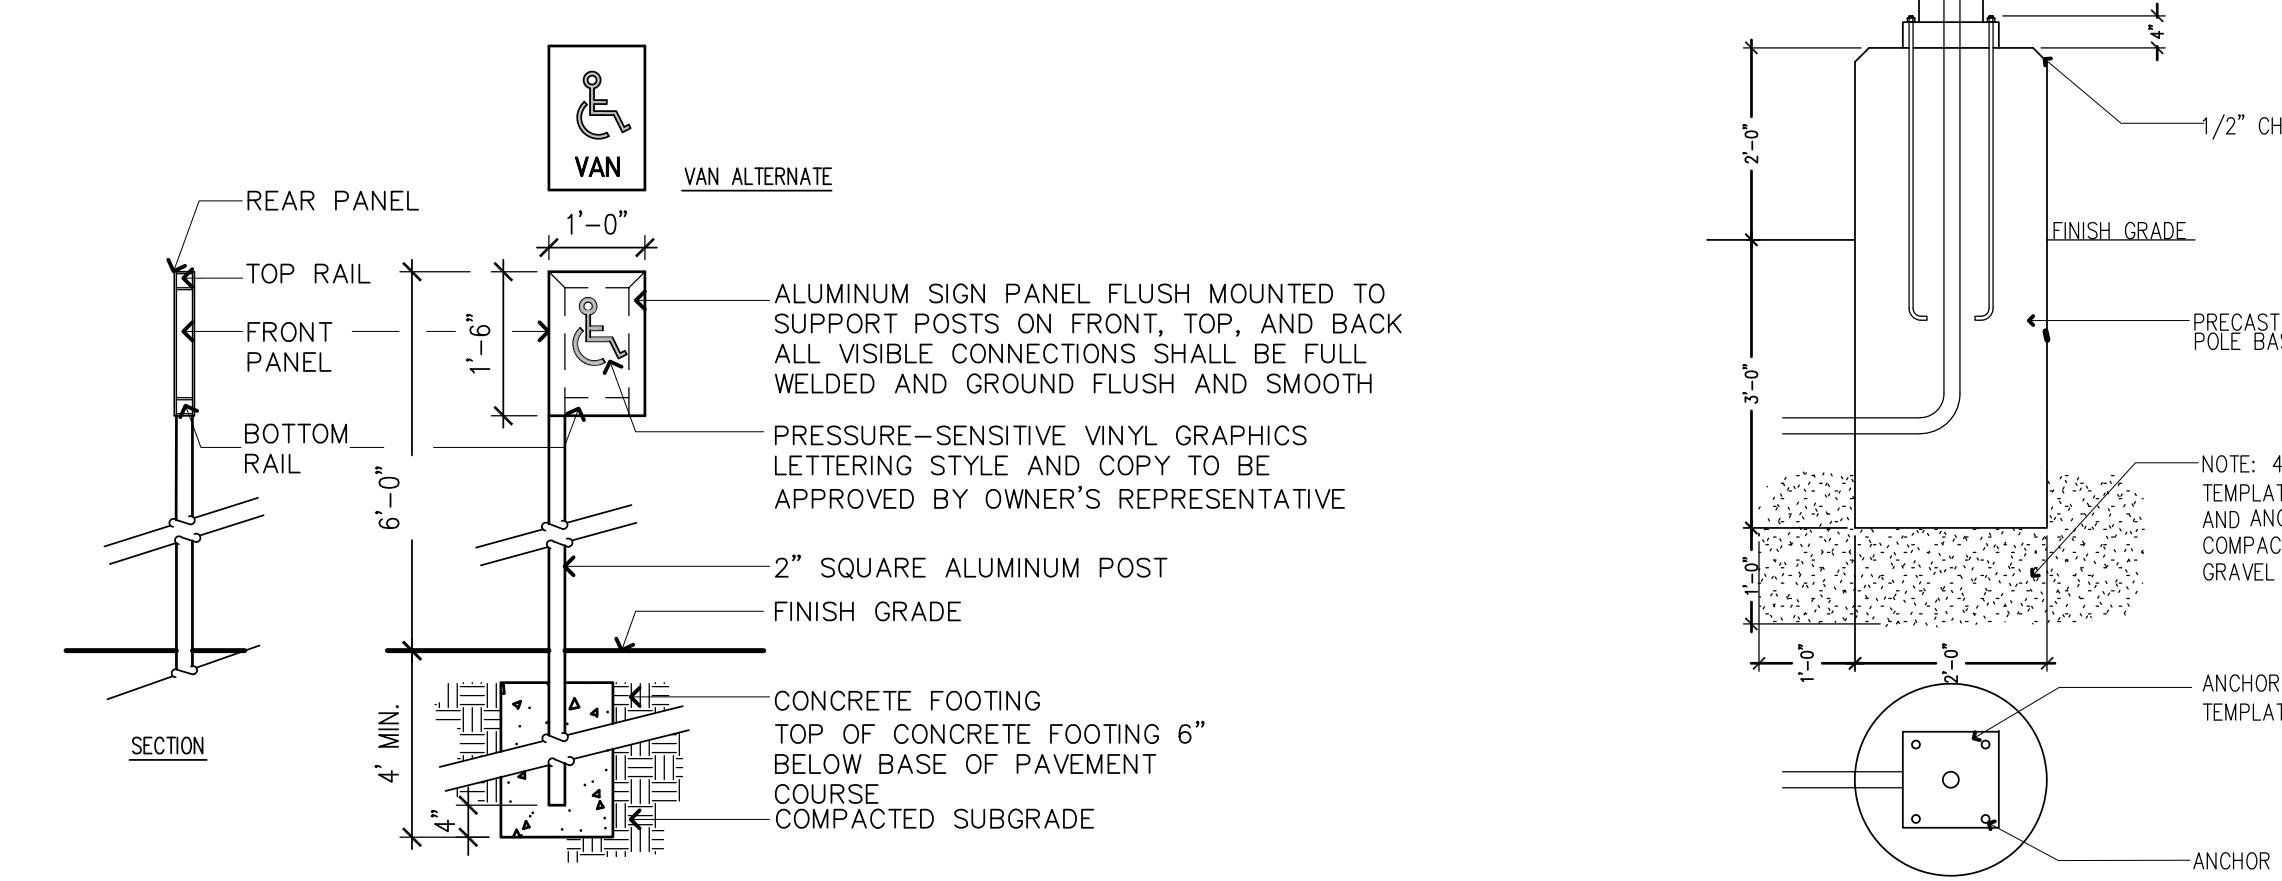

HANDICAP PARKING SIGN


LIGHT POLE BASE

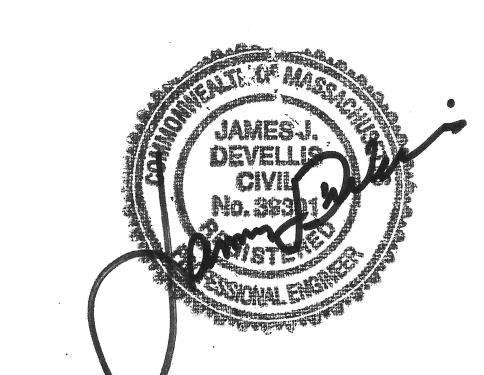

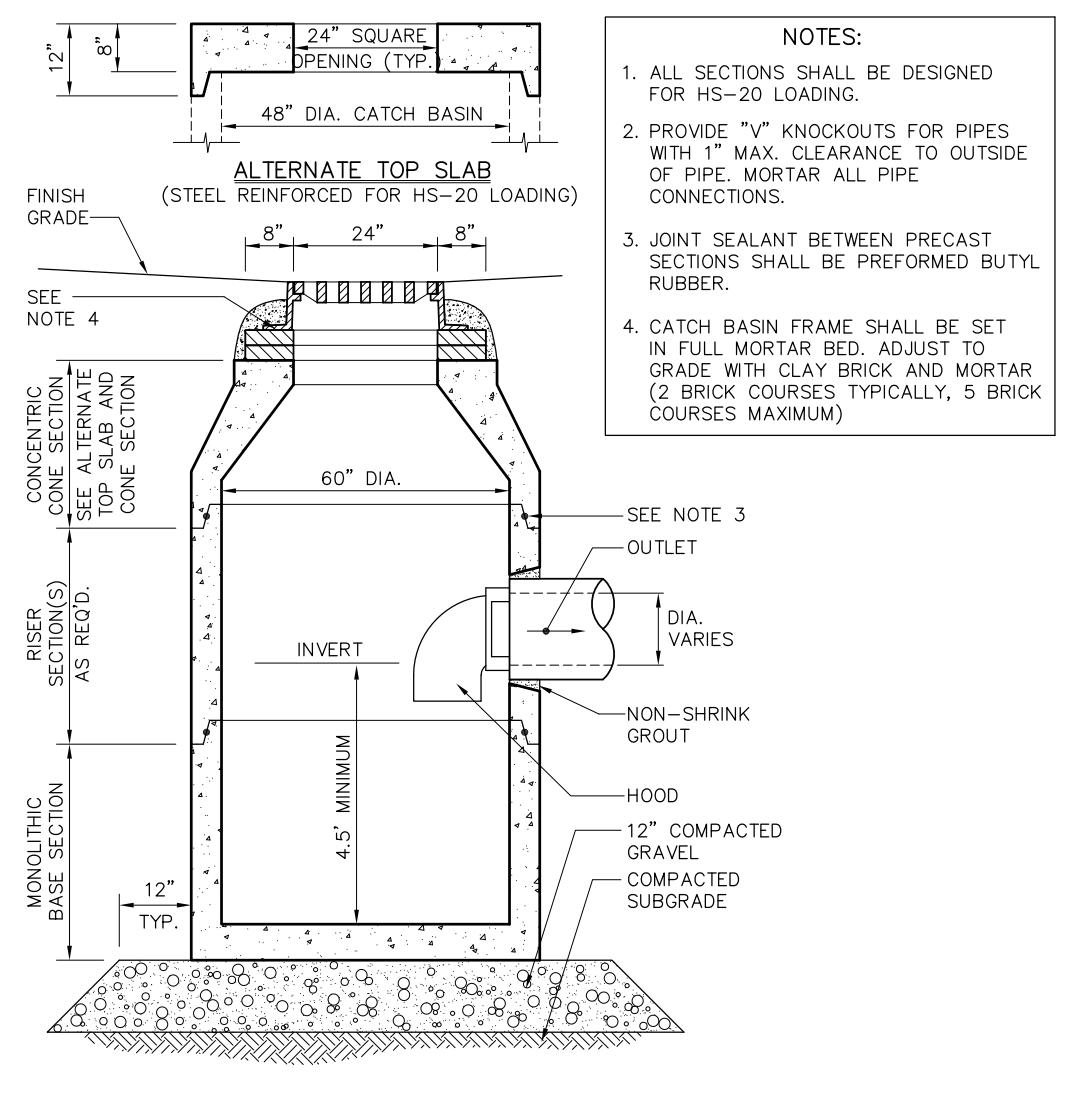


CATCH BASIN (CB)


STC 450i Precast Concrete Stormceptor[®]
(450 U.S. Gallon Capacity)

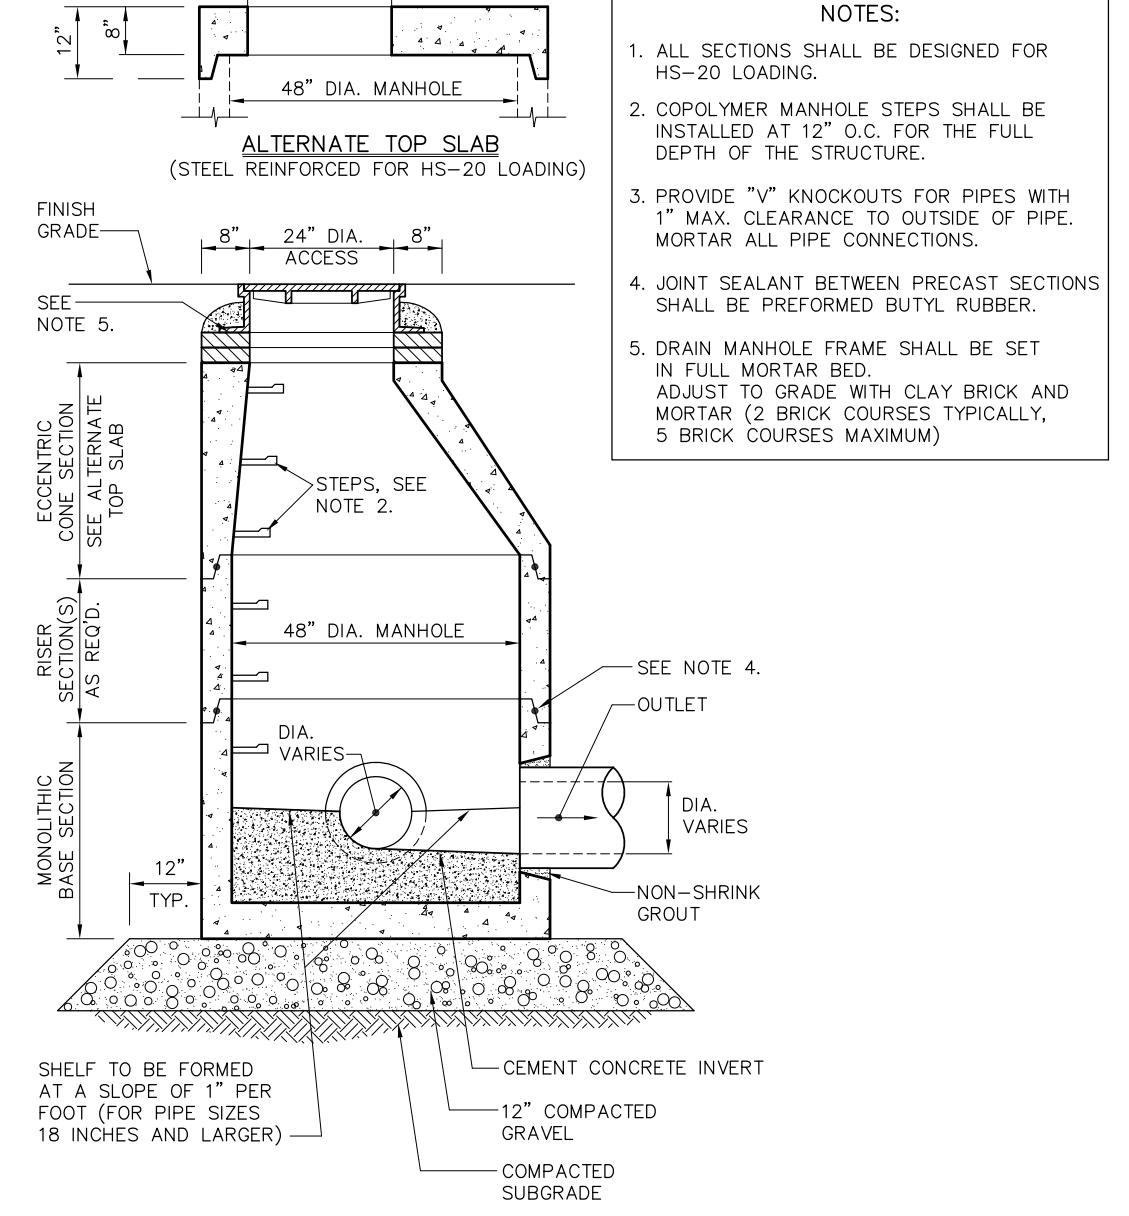


DRAIN MANHOLE (DMH)

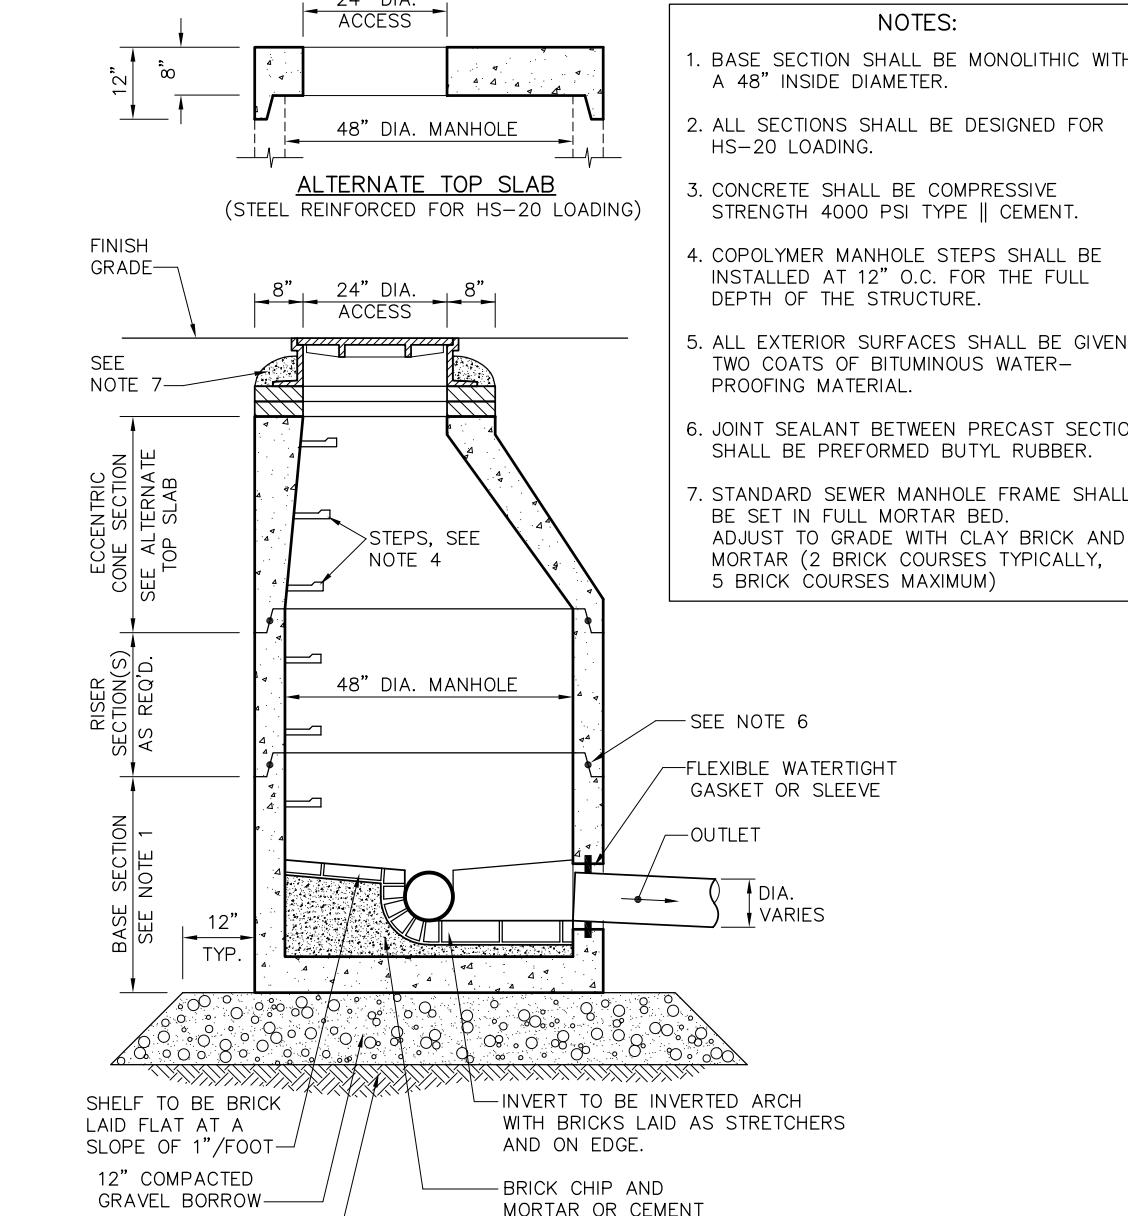

SEWER MANHOLE (SMH)

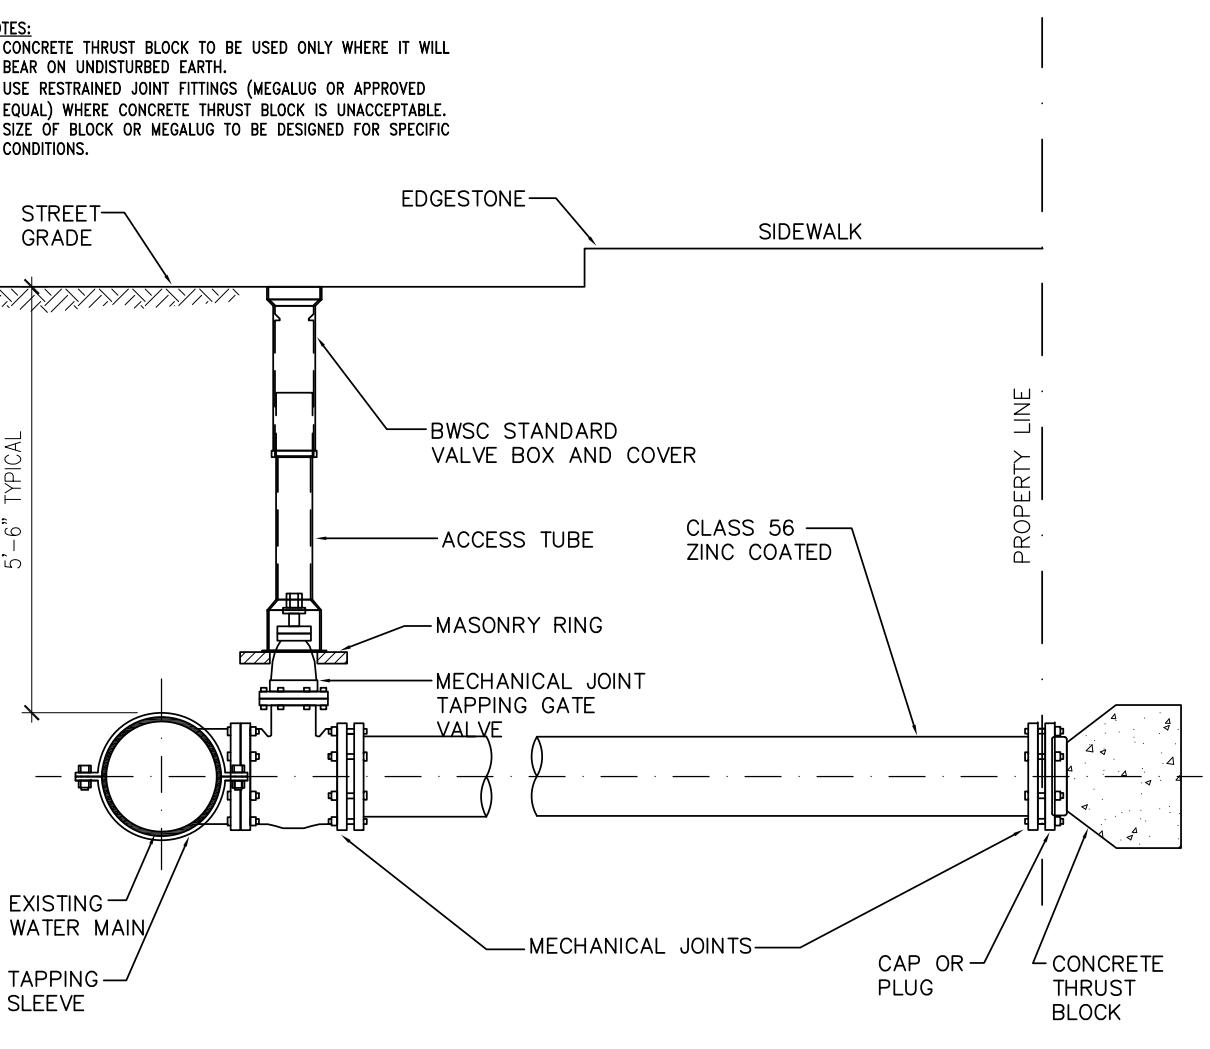


TAPPING SLEEVE AND GATE

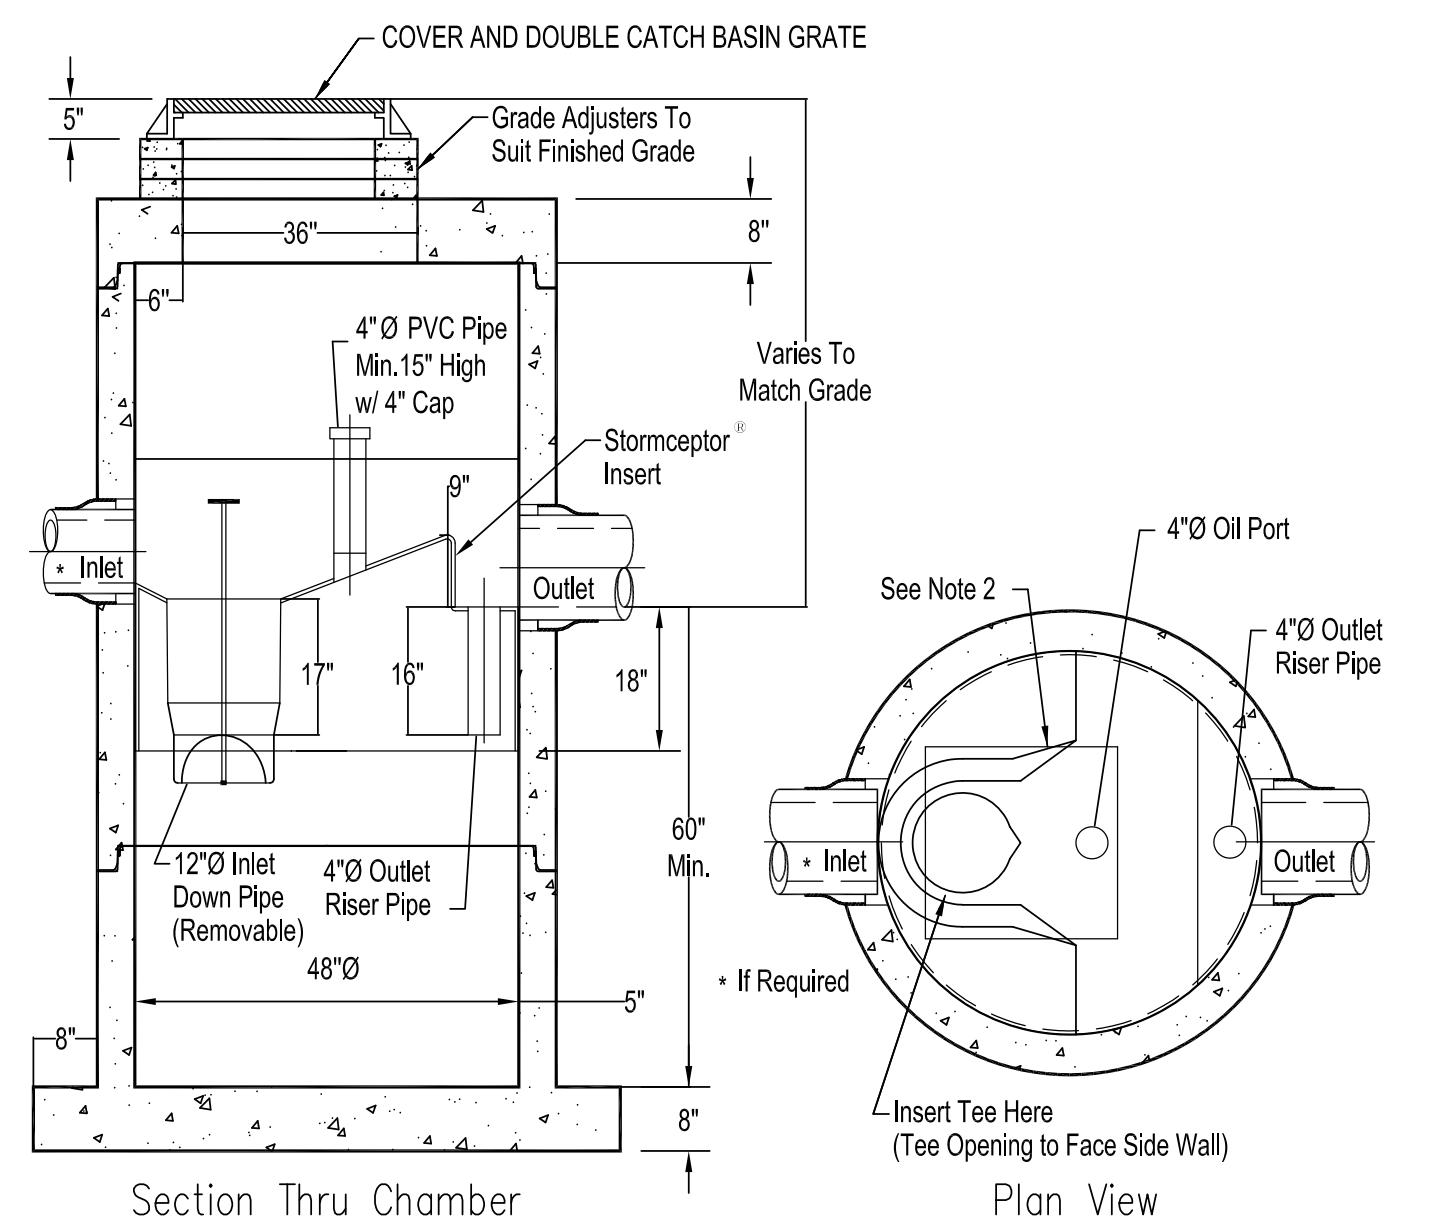


Notes:
1. The Use of Flexible Connection is Recommended at The Inlet and Outlet Where Applicable.
2. The Cover Should be Positioned Over The Inlet Drop Pipe and The Oil Port.
3. The Stormceptor System is protected by one or more of the following U.S. Patents: #4985145, #5498331, #5725760, #5753115, #5849181, #6068765, #6371690.

STORMCEPTOR 450i

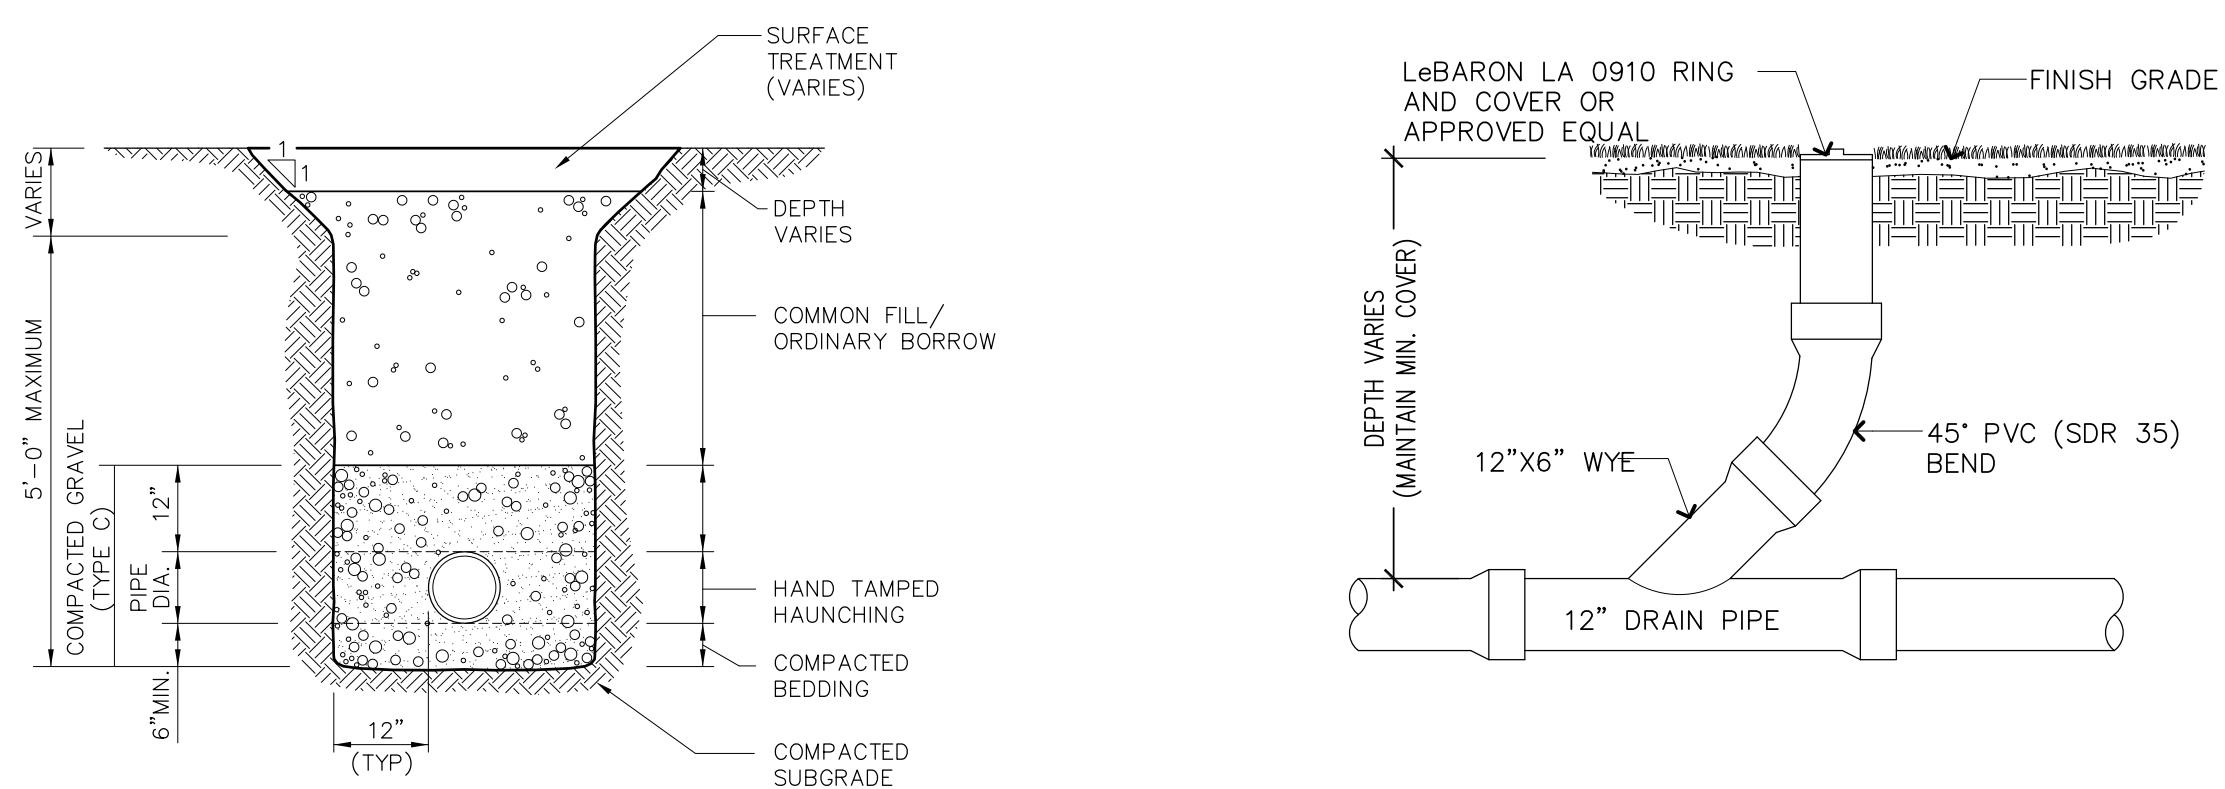

UTILITY TRENCH

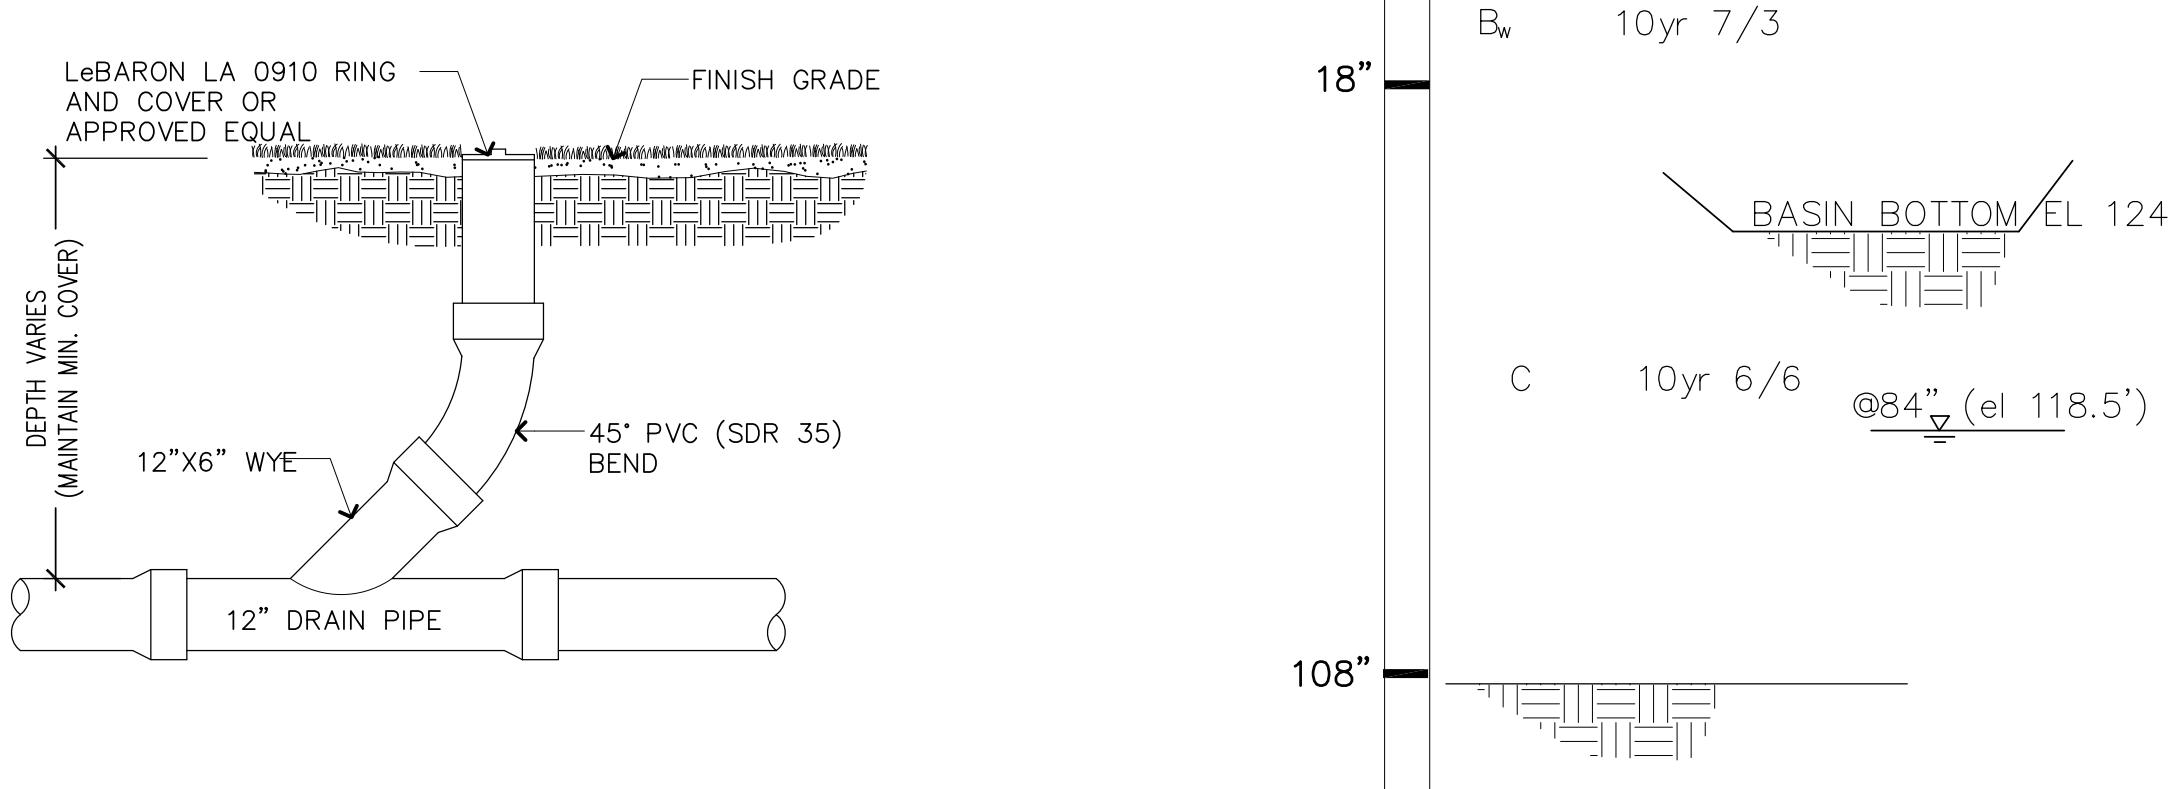


CLEAN OUT

HYDRANT

OUTLET CONTROL STRUCTURE

TEST PIT (TP1)
ELEV. = 125.5' ±

SOIL HORIZON (MUNSELL) SOIL COLOR (MUNSELL) SOIL MOTTLING

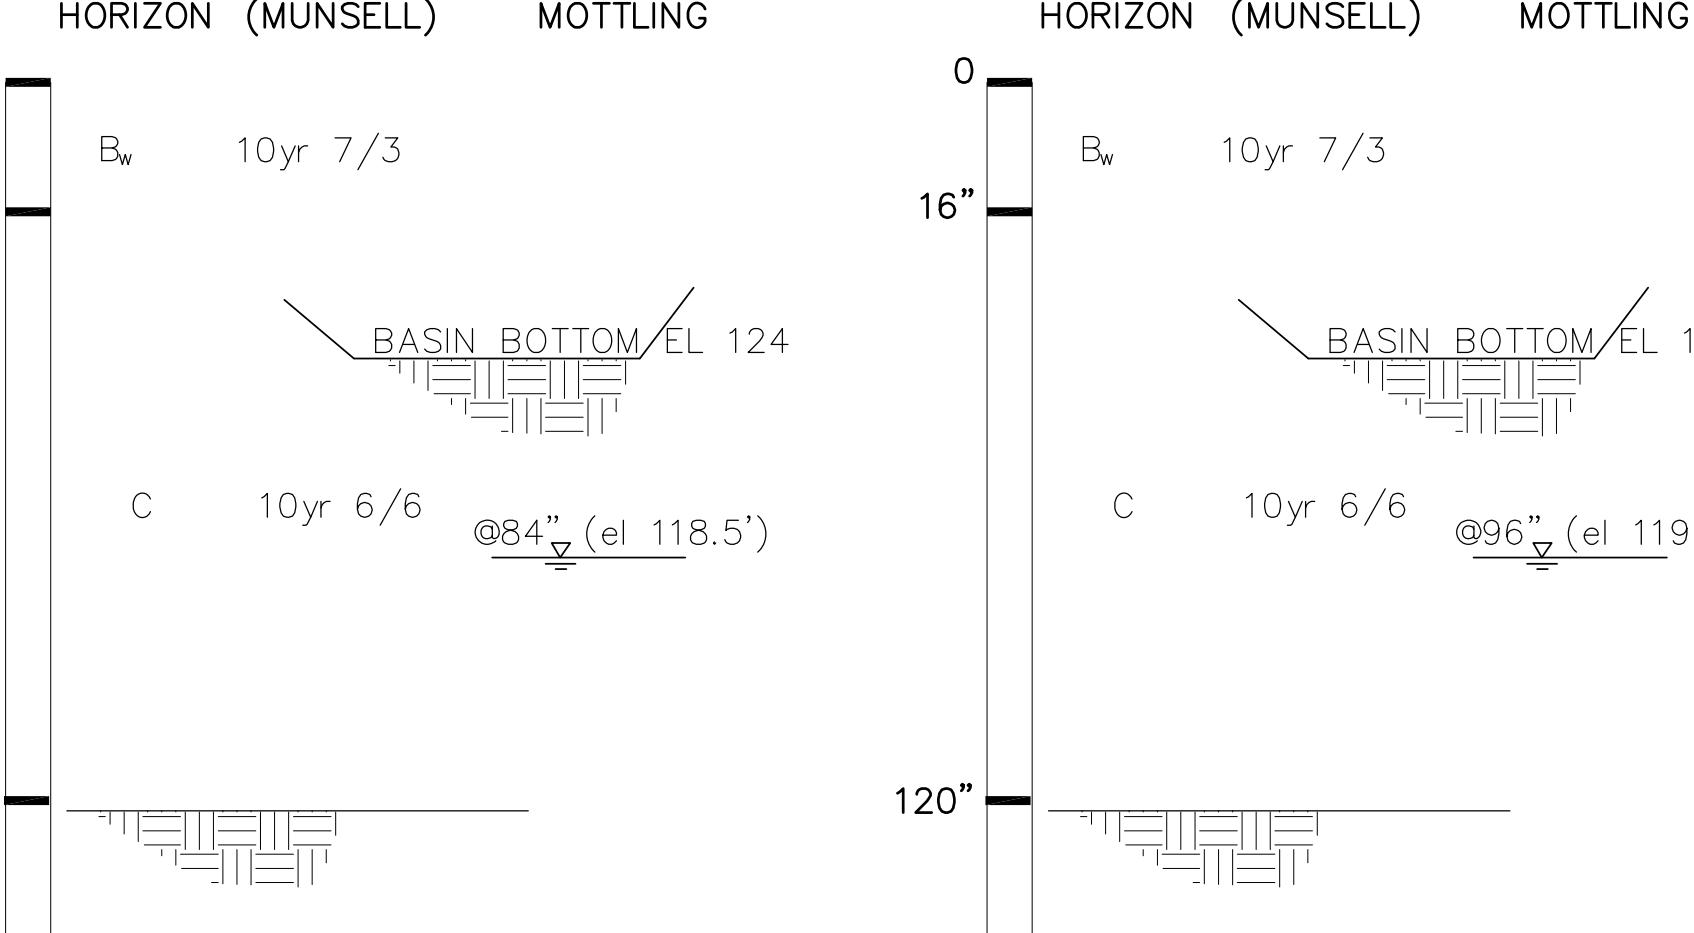


NOTE: TEST PIT WAS PERFORMED ON AUGUST 4, 2022.
THE TESTING WAS PERFORMED BY SOIL EVALUATOR/PE
JAMES J DEVELLIS,PE OF DEVELLIS ZREIN INC.

FLARED END SECTION


TEST PIT (TP2)
ELEV. = 127.5' ±

SOIL HORIZON (MUNSELL) SOIL COLOR (MUNSELL) SOIL MOTTLING

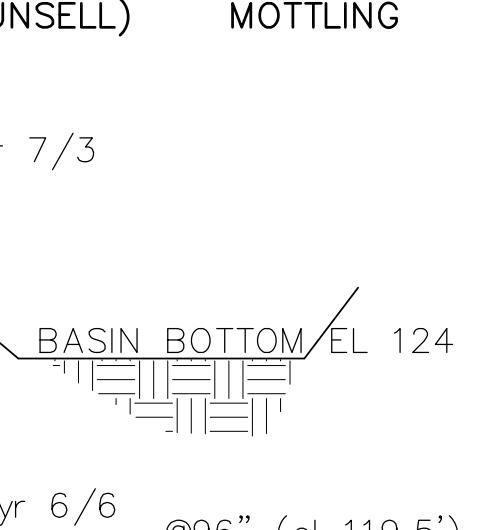

NOTE: TEST PIT WAS PERFORMED ON AUGUST 4, 2022.
THE TESTING WAS PERFORMED BY SOIL EVALUATOR/PE
JAMES J DEVELLIS,PE OF DEVELLIS ZREIN INC.

TEST PIT LOGS

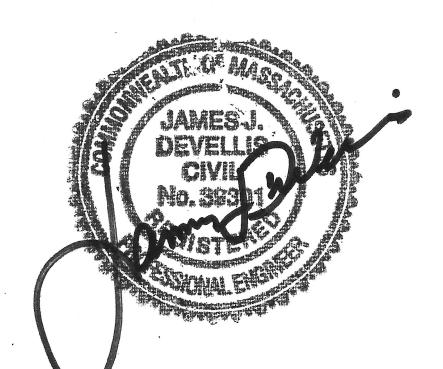

DZI
DeVellis Zren Inc.